

HAVE BEEN COMPLETED. DRAWING NAME: Y:\projects-fo\2023\2309900 - west campus hs\CAD_CVR-DSA.dwg PLOT DATE: 04-25-24 PLOTTED BY: station40-t


SYSTEMS CONFORM AND PASS THE REQUIRED ACCEPTANCE CRITERIA. PROJECT INSPECTORS WILL COLLECT THE FORMS TO CONFIRM THAT THE REQUIRED ACCEPTANCE TESTS

CONSTRUCTION DRAWINGS FOR WEST CAMPUS HIGH SCHOOL BASEBALL AND SOFTBALL IMPROVEMENTS 5022 58TH STREET

STELENGINEERIN

SACRAMENTO, CA 95820 SACRAMENTO CITY UNIFIED SCHOOL DISTRICT NO. 0521-470 VERDE DESIGN, INC PROJECT NO. 2309900 DSA APPLICATION NO. 02-121908

PREPARED BY

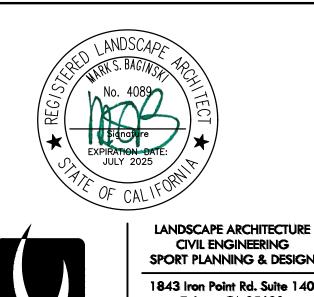

VERDE DESIGN



ALL IDEAS, DESIGNS, ARRANGEMENTS, AND PLANS INDICATE OR REPRESENTED BY THIS DRAWING ARE OWNED BY AND THE ROPERTY OF VERDE DESIGN, INC., AND WERE CREATED VOLVED, AND DEVELOPED FOR USE ON AND IN DEAS, DESIGNS, ARRANGEMENTS OR PLANS SHALL BE USEI REPRODUCED. OR PUBLISHED BY ANY METHOD IN WHOLE OR IN PART, OR DISCLOSED TO ANY PERSON, FIRM OF CORPORATION FOR ANY PURPOSE WHATSOEVER WITHOUT WRITTEN PERMISSION OF VERDE DESIGN, INC.

SCOPE OF WORK

SCOPE OF WORK TO INCLUDE, BUT NOT BE LIMITED TO, THE FOLLOWING: REMOVAL OF EXISTING VARSITY BASEBALL AND SOFTBALL BACKSTOPS, DUGOUTS AND FENCING. NATURAL TURF BASEBALL AND SOFTBALL FIELDS TO BE RELOCATED. IMPROVEMENTS AT THE BASEBALL AND SOFTBALL FIELDS TO INCLUDE CONSTRUCTION OF NEW 30' TALL CHAIN LINK BACKSTOPS WITH 30' TALL NETTING CONTINUING DOWN FOUL LINES, HOME CMU DUGOUTS WITH STORAGE ROOM. VISITOR DUGOUTS TO BE CHAIN LINK FENCE WITH SLOPED METAL ROOF. SINGLE STATION BULLPENS FOR BOTH HOME AND VISITOR SIDE AT EACH FIELD. TWO SINGLE STATION BATTING CAGES WITH SLOPED METAL ROOFS AND INTERNAL LIGHTING FOR BOTH BASEBALL AND SOFTBALL. TO BE PROVIDED WITH ONE SCOREBOARD AND TWO FLAG POLES AT EACH FIELD. PERIMETER FENCING FOR EACH FIELD WITH FOUL POLES. PRE ENGINEERED RESTROOM BUILDING. INSTALLATION OF ASSOCIATED HARDSCAPE, FENCING, LANDSCAPE, IRRIGATION, DRINKING FOUNTAINS, DRAINAGE AND SITE UTILITIES, ELECTRICAL AND PATH OF TRAVEL UPGRADES FOR ACCESSIBILITY. SETS OF 4 ROW BLEACHERS AND HARDSCAPE AT SOCCER FIELD.

The Alameda, Suite 200

San Jose, California 95126

American Consulting

Engineers

Electrical, Inc.

Fax 408.236.2316

BID ADDITIVE ALTERNATES


ADDITIVE ALTERNATE #01: TRACK SURFACE SHALL BE ALL WEATHER SURFACING OVER ASPHALT PAVING IN LIEU OF DECOMPOSED GRANITE. DEFERRED ITEM: N/A

GENERAL NOTES

- PRIOR TO BIDDING, THE GENERAL CONTRACTOR SHALL VISIT & INSPECT THE SITE & FAMILIARIZE THEMSELVES WITH EXISTING CONDITIONS AFFECTING THE NEW WORK. THE GENERAL CONTRACTOR SHALL NOT DISPUTE COMPLAIN OR ASSERT THAT THERE IS ANY MISUNDERSTANDING IN REGARDS TO LOCATION, EXTENT, NATURE OR AMOUNT OF WORK TO BE PERFORMED UNDER THIS CONTRACT DUE TO THE CONTRACTOR'S FAILURE TO INSPECT THE SITE. CONTRACTOR SHALL NOTIFY SACRAMENTO CITY UNIFIED SCHOOL DISTRICT'S REPRESENTATIVE OF ANY CONDITIONS, REQUIRING WORK, WHICH ARE NOT COVERED IN THE CONTRACT DOCUMENTS. NO CONSTRUCTION SHALL COMMENCE WITHOUT THE OFFICIAL NOTICE TO PROCEED FROM THE SACRAMENTO CITY UNIFIED SCHOOL DISTRICT.
- THE GENERAL CONTRACTOR & SUBCONTRACTORS ARE RESPONSIBLE FOR LOCATING & VERIFYING ALL EXISTING UNDERGROUND UTILITIES IN ALL AREAS OF NEW WORK PRIOR TO COMMENCEMENT OF EXCAVATION. EXISTING UTILITIES SHOWN ON THE DRAWINGS ARE APPROXIMATE ROUTING LOCATIONS AS BEST DETERMINED FROM EXISTING DRAWINGS AND THE SCHOOL SACRAMENTO CITY UNIFIED SCHOOL DISTRICT, BUT SHOULD NOT BE CONSTRUED TO REPRESENT ALL OF THE EXISTING UNDERGROUND UTILITIES. THE CONTRACTOR SHALL POTHOLE ALL EXISTING UTILITIES THAT MAY BE AFFECTED BY NEW FACILITIES IN THIS CONTRACT. VERIFY ACTUAL LOCATION AND DEPTH OF UTILITIES, AND REPORT POTENTIAL CONFLICTS TO THE SACRAMENTO CITY UNIFIED SCHOOL DISTRICT'S REPRESENTATIVE PRIOR TO EXCAVATING FOR NEW FACILITIES. CONTRACTOR SHALL TAKE ALL NECESSARY STEPS TO PROTECT ALL EXISTING UTILITIES, WHETHER SHOWN OR NOT, IN THE CONTRACT DOCUMENTS. CONTRACTOR SHALL BE RESPONSIBLE FOR ALL DAMAGES TO EXISTING JTILITIES CAUSED BY ITS OPERATIONS.
- THE CONTRACTOR SHALL PROTECT ALL EXISTING ITEMS WITHIN SITE IMPROVEMENTS. IT IS THE RESPONSIBILITY OF THE CONTRACTOR TO REPAIR ALL DAMAGED AREAS TO THEIR ORIGINAL CONDITION OR BETTER AT CONTRACTOR'S EXPENSE TO THE SATISFACTION OF THE SACRAMENTO CITY UNIFIED SCHOOL DISTRICT'S REPRESENTATIVE. DIMENSIONS AND LOCATIONS OF EXISTING FACILITIES ARE APPROXIMATE AND SHALL BE FIELD VERIFIED BY CONTRACTOR. ANY DISCREPANCIES SHALL BE IMMEDIATELY BROUGHT TO THE ATTENTION OF THE SACRAMENTO CITY UNIFIED SCHOOL DISTRICT'S REPRESENTATIVE.
- ALL WORK SHALL CONFORM TO THE LATEST EDITION OF THE CALIFORNIA BUILDING CODE, CALIFORNIA PLUMBING CODE, CALIFORNIA FIRE CODE AND ALL APPLICABLE STATE AND LOCAL CODES AND ORDINANCES, AS WELL AS ADAPTED STANDARDS. ALL NOTES ARE FOR GENERAL REFERENCE IN CONJUNCTION WITH, AND AS A SUPPLEMENT TO, THE WRITTEN SPECIFICATIONS AND DETAILS ASSOCIATED WITH THE CONTRACT DOCUMENTS. THIS DRAWING SET SHALL BE USED IN CONJUNCTION WITH THE CSI FORMAT SPECIFICATIONS PUBLISHED IN BOOK FORM. COMBINED, THEY ARE HEREIN REFERRED TO AS THE "CONTRACT DOCUMENTS".
- DIMENSIONS ON WORKING DRAWINGS TAKE PRECEDENCE OVER MEASURED ELEMENTS. CONTRACTOR SHALL NOT SCALE DRAWINGS. ALL TYPICAL DETAILS SHALL APPLY UNLESS NOTED OTHERWISE. 12.
- CONTRACTOR SHALL PROVIDE ADEQUATE DUST CONTROL AND KEEP MUD AND DEBRIS OFF THE PUBLIC RIGHT-OF-WAY AT ALL TIMES. 13. ALL TRENCHES AND EXCAVATIONS SHALL BE CONSTRUCTED IN STRICT COMPLIANCE WITH THE APPLICABLE SECTIONS OF CALIFORNIA AND FEDERAL O.S.H.A. REQUIREMENTS AND OTHER APPLICABLE SAFETY ORDINANCES. CONTRACTOR SHALL BEAR FULL RESPONSIBILITY FOR TRENCH SHORING DESIGN AND INSTALLATION. ANY ALTERATIONS OF EXISTING FACILITIES TO ACCOMMODATE THE INSTALLATION OF NEW WORK SHALL BE REVIEWED BY THE SACRAMENTO CITY UNIFIED SCHOOL DISTRICT'S REPRESENTATIVE PRIOR TO COMMENCING WORK
- CONTRACTOR SHALL COORDINATE ALL WORK TO AVOID DISTURBING STUDENTS OR TEACHERS DURING SCHOOL HOURS. ANY DISRUPTION OF THE UTILITIES MUST BE COORDINATED AND APPROVED BY THE SACRAMENTO 15. CITY UNIFIED SCHOOL DISTRICT'S REPRESENTATIVE AND INSPECTOR OF RECORD PRIOR TO COMMENCING WORK. ALL TEMPORARY WORK SHALL BE CONSIDERED A PART OF THIS CONTRACT AND NO EXTRA CHARGES WILL BE ALLOWED. THIS SHALL INCLUDE MINOR ITEMS OF MATERIAL OR EQUIPMENT NECESSARY TO MEET THE REQUIREMENTS AND INTENT OF THE PROJECT
- THE PLANS AND SPECIFICATIONS DO NOT UNDERTAKE TO SHOW OR LIST EVERY ITEM TO BE PROVIDED, BUT RATHER TO DEFINE THE REQUIREMENTS FOR A FULL AND WORKING SYSTEM FROM THE STANDPOINT OF THE END USER. FOR THIS REASON, WHEN AN ITEM NOT SHOWN OR LISTED IS CLEARLY NECESSARY FOR PROPER CONTROL/OPERATION OF EQUIPMENT WHICH IS SHOWN OR LISTED, THE CONTRACTOR SHALL PROVIDE AN ITEM WHICH WILL ALLOW THE SYSTEM TO FUNCTION PROPERLY AT NO INCREASE IN PRICE. 18. ALL CONTRACTORS SHALL REMOVE TRASH AND DEBRIS STEMMING FROM THEIR WORK ON A DAILY BASIS. PROJECT SITE SHALL BE MAINTAINED IN A CLEAN AND ORDERLY CONDITION.
- 19. THE DETAILS REFLECT THE DESIGN INTENT FOR TYPICAL CONDITIONS. THE CONTRACTOR SHALL VERIFY ALL FIELD CONDITIONS AND SHALL INCLUDE, IN HIS SCOPE, THE COST FOR COMPLETE FINISHED INSTALLATIONS, NCLUDING ANOMALIES, OF ALL TRADES. 20. NO WORK SHALL COMMENCE WITH UNAPPROVED MATERIALS. ANY WORK DONE WITH UNAPPROVED MATERIALS AND EQUIPMENT IS AT THE CONTRACTOR'S RISK AND IS SUBJECT TO REJECTION AND REPLACEMENT. SEE SPECIFICATIONS FOR SUBMITTAL AND SUBSTITUTION REQUIREMENTS. CONSTRUCTION MATERIALS STORED ON THE SITE SHALL BE PROPERLY STACKED AND PROTECTED SO AS TO PREVENT DAMAGE OR DETERIORATION UNTIL USED. FAILURE IN THIS REGARD MAY BE CAUSE FOR REJECTION OF
- MATERIAL AND/OR WORK. ALL EQUIPMENT SHALL BE FABRICATED FROM FIELD VERIFIED DIMENSIONS AND APPROVED SHOP DRAWINGS. COORDINATE MECHANICAL, PLUMBING AND ELECTRICAL EQUIPMENT. CONTRACTOR SHALL PERFORM THEIR CONSTRUCTION AND OPERATIONS IN A MANNER WHICH WILL NOT ALLOW HARMFUL POLLUTANTS TO ENTER THE STORM DRAIN SYSTEM. TO ENSURE COMPLIANCE, THE CONTRACTOR
- SHALL IMPLEMENT THE APPROPRIATE BEST MANAGEMENT PRACTICE (BMP) AS OUTLINED IN THE BROCHURES ENTITLED "BEST MANAGEMENT PRACTICE FOR THE CONSTRUCTION INDUSTRY" ISSUED BY THE CALIFORNIA STORM WATER QUALITY ASSOCIATION. NONPOINT SOURCE POLLUTION CONTROL PROGRAM. TO SUIT THE CONSTRUCTION SITE AND JOB CONDITION. THE CONTRACTOR SHALL PRESENT THEIR PROPOSED BMP AT THE PRECONSTRUCTION MEETING FOR DISCUSSION AND APPROVAL. CONTRACTOR SHALL PROVIDE TEMPORARY CONSTRUCTION FENCING PER CONTRACT DOCUMENTS TO SERVE LIMIT OF WORK AREAS. FENCING MAY BE ADJUSTED DURING CONSTRUCTION BASED ON CONSTRUCTION SEQUENCE OR SACRAMENTO CITY UNIFIED SCHOOL DISTRICT REPRESENTATIVE'S DIRECTION.
- OVERNIGHT PARKING OF CONSTRUCTION EQUIPMENT IN THE STREET RIGHT-OF-WAY SHALL NOT BE PERMITTED.

DSA SUPPLEMENTARY CONDITIONS

- 1. FABRICATION AND INSTALLATION OF DEFERRED SUBMITTAL ITEMS SHALL NOT BE STARTED UNTIL CONTRACTOR'S DRAWINGS, SPECIFICATIONS, AND ENGINEERING CALCULATIONS FOR THE ACTUAL SYSTEMS TO BE INSTALLED HAVE BEEN ACCEPTED AND SIGNED BY THE ARCHITECT OR STRUCTURAL ENGINEER AND APPROVED BY THE DSA. LIST DEFERRED SUBMITTAL ITEMS FOR THIS PROJECT. 2. CHANGES TO THE APPROVED DRAWINGS AND SPECIFICATIONS SHALL BE MADE BY AN ADDENDUM OR A CONSTRUCTION CHANGED DOCUMENT (CCD) APPROVED BY THE DIVISION OF THE STATE ARCHITECT PRIOR TO
- FABRICATION AND INSTALLATION, AS REQUIRED BY SECTION 4-338, PART 1, TITLE 24, CCR AND DSA IR-6. 3. A "DSA CERTIFIED" PROJECT INSPECTOR (MIN CLASS 2) EMPLOYED BY THE DISTRICT (OWNER) AND APPROVED BY THE DSA SHALL PROVIDE CONTINUOUS INSPECTION OF THE WORK. THE DUTIES OF THE INSPECTOR ARE
- DEFINED IN SECTION 4-342, PART 1, TITLE 24, CCR. 4. A DSA ACCEPTED TESTING LABORATORY DIRECTLY EMPLOYED BY THE DISTRICT (OWNER) SHALL CONDUCT ALL THE REQUIRED TESTS AND INSPECTIONS FOR THE PROJECT. 5. THE INTENT OF THESE DRAWINGS AND SPECIFICATIONS IS THAT THE WORK OF THE ALTERATION, REHABILITATION OR RECONSTRUCTION IS TO BE IN ACCORDANCE WITH TITLE 24, CCR. SHOULD ANY EXISTING CONDITIONS SUCH AS DETERIORATION OR NON-COMPLYING CONSTRUCTION BE DISCOVERED WHICH IS NOT COVERED BY THE CONTRACT DOCUMENTS WHEREIN THE FINISHED WORK WILL NOT COMPLY WITH TITLE 24, CCR, A CONSTRUCTION CHANGE DOCUMENT (CCD), OR A SEPARATE SET OF PLANS AND SPECIFICATIONS, DETAILING AND SPECIFYING THE REQUIRED WORK SHALL BE SUBMITTED TO AND APPROVED BY DSA BEFORE PROCEEDING
- WITH THE WORK. (SECTION 4-317(C), PART 1, TITLE 24, CCR) 6. GRADING PLANS, DRAINAGE IMPROVEMENTS, ROAD AND ACCESS REQUIREMENTS AND ENVIRONMENTAL HEALTH CONSIDERATIONS SHALL COMPLY WITH ALL LOCAL ORDINANCES. 7. THE PROJECT WILL BE COMPLIANT WITH CFC CH. 33 - FIRE SAFETY DURING CONSTRUCTION AND DEMOLITION

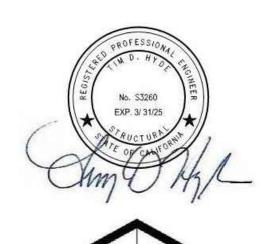



Structural Engineers, Inc 275 Tennant Avenue, Ste. B ph: 408.978.1970 Morgan Hill, California 95037 web: AKHSE.com

CONTACT INFORMATION

| ORGANIZATION | NAME | PHONE |
|---|---------------------------------|----------------------------------|
| OWNER SACRAMENTO CITY UNIFIED SCHOOL DISTRICT | CHRIS RALSTON | (916) 395-9230 |
| <u>CIVIL ENGINEER/ LANDSCAPE ARCHITECT</u> VERDE DESIGN INC. | CHRIS SULLIVAN MARK BAGINSKI | (916) 996-5525 (408) 850-3411 |
| ELECTRICAL ENGINEER AMERICAN CONSULTING ENGINEERS ELECTRICAL INC. | SAMMY FERNANDEZ | (408) 236-2312 |
| STRUCTURAL ENGINEER AKH STRUCTURAL ENGINEERS INC. | TIM HYDE | (408) 978-1970 |
| ROMTEC STRUCTURAL ENGINEER 4 STEL ENGINEERS | DUSTIN ROSEPINK | (949) 305-1150 |

| SHE | ET INDEX 114 Sheets | | |
|--------------|--|------------------|--------------------|
| | IO. SHEET DESCRIPTION | ELECTRIC | AL |
| | | E0.1 | |
| LANDSC | APE | | SCHEDUI |
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| L0.2 | FIRE, LIFE, & SAFETY PLAN | E1.1 | ELECTRIC |
| L1.1 | EXISTING CONDITIONS AND SURVEY PLAN | E1.2 | ELECTRIC |
| L1.2 | EXISTING CONDITIONS AND SURVEY PLAN | E2.1 | ELECTRIC |
| L1.3 | EXISTING CONDITIONS AND SURVEY PLAN | E2.2 | ELECTRIC |
| L2.1 | EROSION AND SEDIMENT CONTROL PLAN - SOFTBALL | E3.1 | ELECTRIC |
| | AND PARKING | E3.2 | ELECTRIC |
| L2.2 | EROSION AND SEDIMENT CONTROL PLAN - BASEBALL | E3.3 | ELECTRIC |
| L2.3 | EROSION AND SEDIMENT CONTROL PLAN - TRACK | | SOFTBAL |
| L3.1 | DEMOLITION PLAN - SOFTBALL AND PARKING | E5.1 | ELECTRIC |
| L3.2 | DEMOLITION PLAN - BASEBALL | E7.1 | ELECTRIC |
| L3.3 | DEMOLITION PLAN - TRACK | E7.2 | ELECTRIC |
| L4.1 | GRADING PLAN - SOFTBALL AND PARKING | E7.3 | ELECTRIC |
| L4.2 | GRADING PLAN - BASEBALL | E7.4 | ELECTRIC |
| L4.3 | GRADING PLAN - TRACK | E7.5 | ELECTRIC |
| L5.1 | DRAINAGE AND UTILITY PLAN - SOFTBALL AND | | |
| | PARKING | | SCOREBOARI |
| L5.2 | DRAINAGE AND UTILITY PLAN - BASEBALL | SB0.1 | COVER S |
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| L7.1 | MATERIAL AND DETAIL REFERENCE PLAN - SOFTBALL | | om Building |
| . — • | AND PARKING | G0 | TITLE SHE |
| L7.2 | MATERIAL AND DETAIL REFERENCE PLAN - BASEBALL | G1 | GENERA |
| L7.3 | MATERIAL AND DETAIL REFERENCE PLAN - TRACK | G2 | DESIGN |
| L8.1 | IRRIGATION PLAN - SOFTBALL AND PARKING | G3 | DESIGN |
| L8.2 | IRRIGATION PLAN - BASEBALL | A1.1 | FLOOR P |
| L8.3 | IRRIGATION PLAN - TRACK | A1.2 | ADA CLE |
| L9.1 | PLANTING PLAN - SOFTBALL AND PARKING | A1.3 | INTERIOR |
| L9.2 | PLANTING PLAN - BASEBALL | A2.1 | EXTERIO |
| L9.3 | PLANTING PLAN - TRACK | A2.2 | EXTERIO |
| 1 10 | | A3.1 | BUILDING |
| D1.1 | DRAINAGE AND UTILITY DETAILS | A3.2 | BUILDINC |
| D1.2 | DRAINAGE AND UTILITY DETAILS | A4.1 | |
| D2.1 D2.2 | CONSTRUCTION DETAILS - HARDSCAPE CONSTRUCTION DETAILS - HARDSCAPE | A5.1 | DOOR S |
| D2.2 D3.1 | ACCESSIBILITY DETAILS | A5.2 | DOOR D |
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| D4.3 D5.1 | CONSTRUCTION DETAIL - BALL FIELDS | \$7.3 | FOUNDA |
| D5.1 D5.2 | CONSTRUCTION DETAIL - BASEBALL | \$7.4 | FOUNDA |
| D5.2 | CONSTRUCTION DETAIL - SOFTBALL | S8.1 | |
| D5.4 | CONSTRUCTION DETAIL - HOME DUGOUT | \$8.2 | |
| D6.1 | PLANTING AND IRRIGATION DETAILS | S8.3 | STRUCTU |
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| <u>S1.1</u> | STRUCTURAL NOTES & MATERIAL GRADES | S9.1 S10.1 | |
| S2.1 | DUGOUT - STORAGE ON LEFT - PLANS, SECTIONS, | \$10.1 \$10.2 | CONNEC |
| 0211 | ELEVATIONS & DETAILS | S10.2 S10.3 | CONNEC |
| S2.2 | DUGOUT STRUCTURAL DETAILS | R1 | ROOFING |
| S8.1 | BB & SB SITE STRUCTURES FOUNDATION DETAILS | R1 R2 | ROOFING |
| S8.2 | BB & SB SITE STRUCTURES FOUNDATION DETAILS | κ∠ P1 | PLUMBIN |
| | | P2 | PLUMBIN |
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| | | AA 2 | |

| Statement | of General | Conformance | |
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FOR ARCHITECTS/ENGINEERS WHO UTILIZE PLANS, INCLUDING BUT NOT LIMITED TO SHOP DRAWINGS, PREPARED BY OTHER LICENSED DESIGN PROFESSIONALS AND/OR CONSULTANTS E10

(Application No. 02-121908 File No.

X The drawings or sheets listed on the cover or index sheet This drawing, page of specifications/calculations

have been prepared by other design professionals or consultants who are licensed and/or

authorized to prepare such drawings in this state. It has been examined by me for: Design intent and appears to meet the appropriate requirements of Title 24, California

Code of Regulations and the project specifications prepared by me, and Coordination with my plans and specifications and is acceptable for incorporation into the construction of this project.

The Statement of General Conformance "shall not be construed as relieving me of my rights duties, and responsibilities under Sections 17302 and 81138 of the Education Code and Sections 4-336, 4-341 and 4-344" of Title 24, Part 1. (Title 24, Part 1, Section 4-317 [b])

| I FIND THAT: | ☑ ALL DRAWINGS OR S ☐ THIS DRAWING OR P | SHEETS LISTED ON THE COVER OR INDEX SHEET PAGE |
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THE PROJECT DESIGN INTENT, AND X HAS/HAVE BEEN COORDINATED WITH THE PROJECT PLANS AND SPECIFICATIONS. 12-13-23

) Hg/ SIGNATURE DATE ARCHITECT OR ENGINEER DESIGNATED TO

BE IN GENERAL RESPONSIBLE CHARGE Tim D. Hyde, S.E.

PRINT NAME 3-31-2025 \$3260 LICENSE NUMBER EXPIRATION DATE HAS/HAVE BEEN COORDINATED WITH THE PROJECT PLANS AND SPECIFICATIONS.

THE PROJECT DESIGN INTENT. AND

SIGNATURE

ARCHITECT OR ENGINEER DELEGATED RESPONSIBILITY FOR THIS PORTION OF THE WORK

DATE

PRINT NAME

LICENSE NUMBER

EXPIRATION DATE

E3

E11

E12


IDENTIFICATION STAN IV. OF THE STATE ARCHIT APP: 02-121908 INC: **REVIEWED FOR** SS 🗹 FLS 🗹 ACS 🗹 DATE: 05/01/2024

CAL SYMBOLS, ABBREVIATIONS, NOTES AND R TITLE 24 CAL DEMOLITION SITE PLAN CAL OVERALL SITE PLAN CAL LIGHTING SITE PLAN AL ENLARGED SOFTBALL SITE PLAN - NEV AL ENLARGED BASEBALL SITE PLAN - NEW AL PLAN - DUGOUTS (SOFTBALL CAL PLAN - DUGOUTS (BASEBALL) AL PLAN - BATTING CAGE - BASEBALL 8 CAL PARTIAL SINGLE LINE DIAGRAM CAL DETAILS CAL DETAILS CAL DETAILS CAL DETAILS CAL DETAILS URAL NOTES & SPECIAL INSPECTIONS OLUMN CAISSON - BOLTED IMENT DETAILS HEET/REVISION & SHEET SCHEDULE AL NOTES/SYMBOL LEGEND I CRITERIA AND CODE SUMMARY I CRITERIA AND CODE SUMMARY PLAN LEAR SPACE **DR ELEVATIONS** OR ELEVATIONS OR ELEVATIONS **IG SECTIONS IG SECTIONS** FINISH SCHEDULE (INTERIOR/EXTERIOR) SCHEDULE DETAILS CHEDULE & DETAILS DATION PLAN DATION OPTIONS DATION DETAILS DATION DETAILS FURAL CMU PLAN EBAR LAYOUT DETAIL **FURAL DETAILS FURAL ELEVATIONS** AENT MOUNTING DETAILS FRAMING PLAN ECTION DETAILS CTION DETAILS CTION DETAILS JG PLAN **IG DETAILS** NG SCHEDULE NG PLAN NICAL PLAN MECHANICAL PLAN ELECTRICAL SCHEDULE ELECTRICAL PLAN ELECTRICAL RISER DETAILS ELECTRICAL PANEL SCHEDULE **TITLE 24 DOCUMENTS** TITLE 24 DOCUMENTS **TITLE 24 DOCUMENTS** TITLE 24 DOCUMENTS **TITLE 24 DOCUMENTS TITLE 24 DOCUMENTS TITLE 24 DOCUMENTS** TITLE 24 DOCUMENTS


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DRAWING NAME: Y:\projects-fo\2023\2309900 - west campus hs\CAD_acc.dwg PLOT DATE: 02-14-24 PLOTTED BY: station40-t



ACCESSIBILITY PLAN NOTES

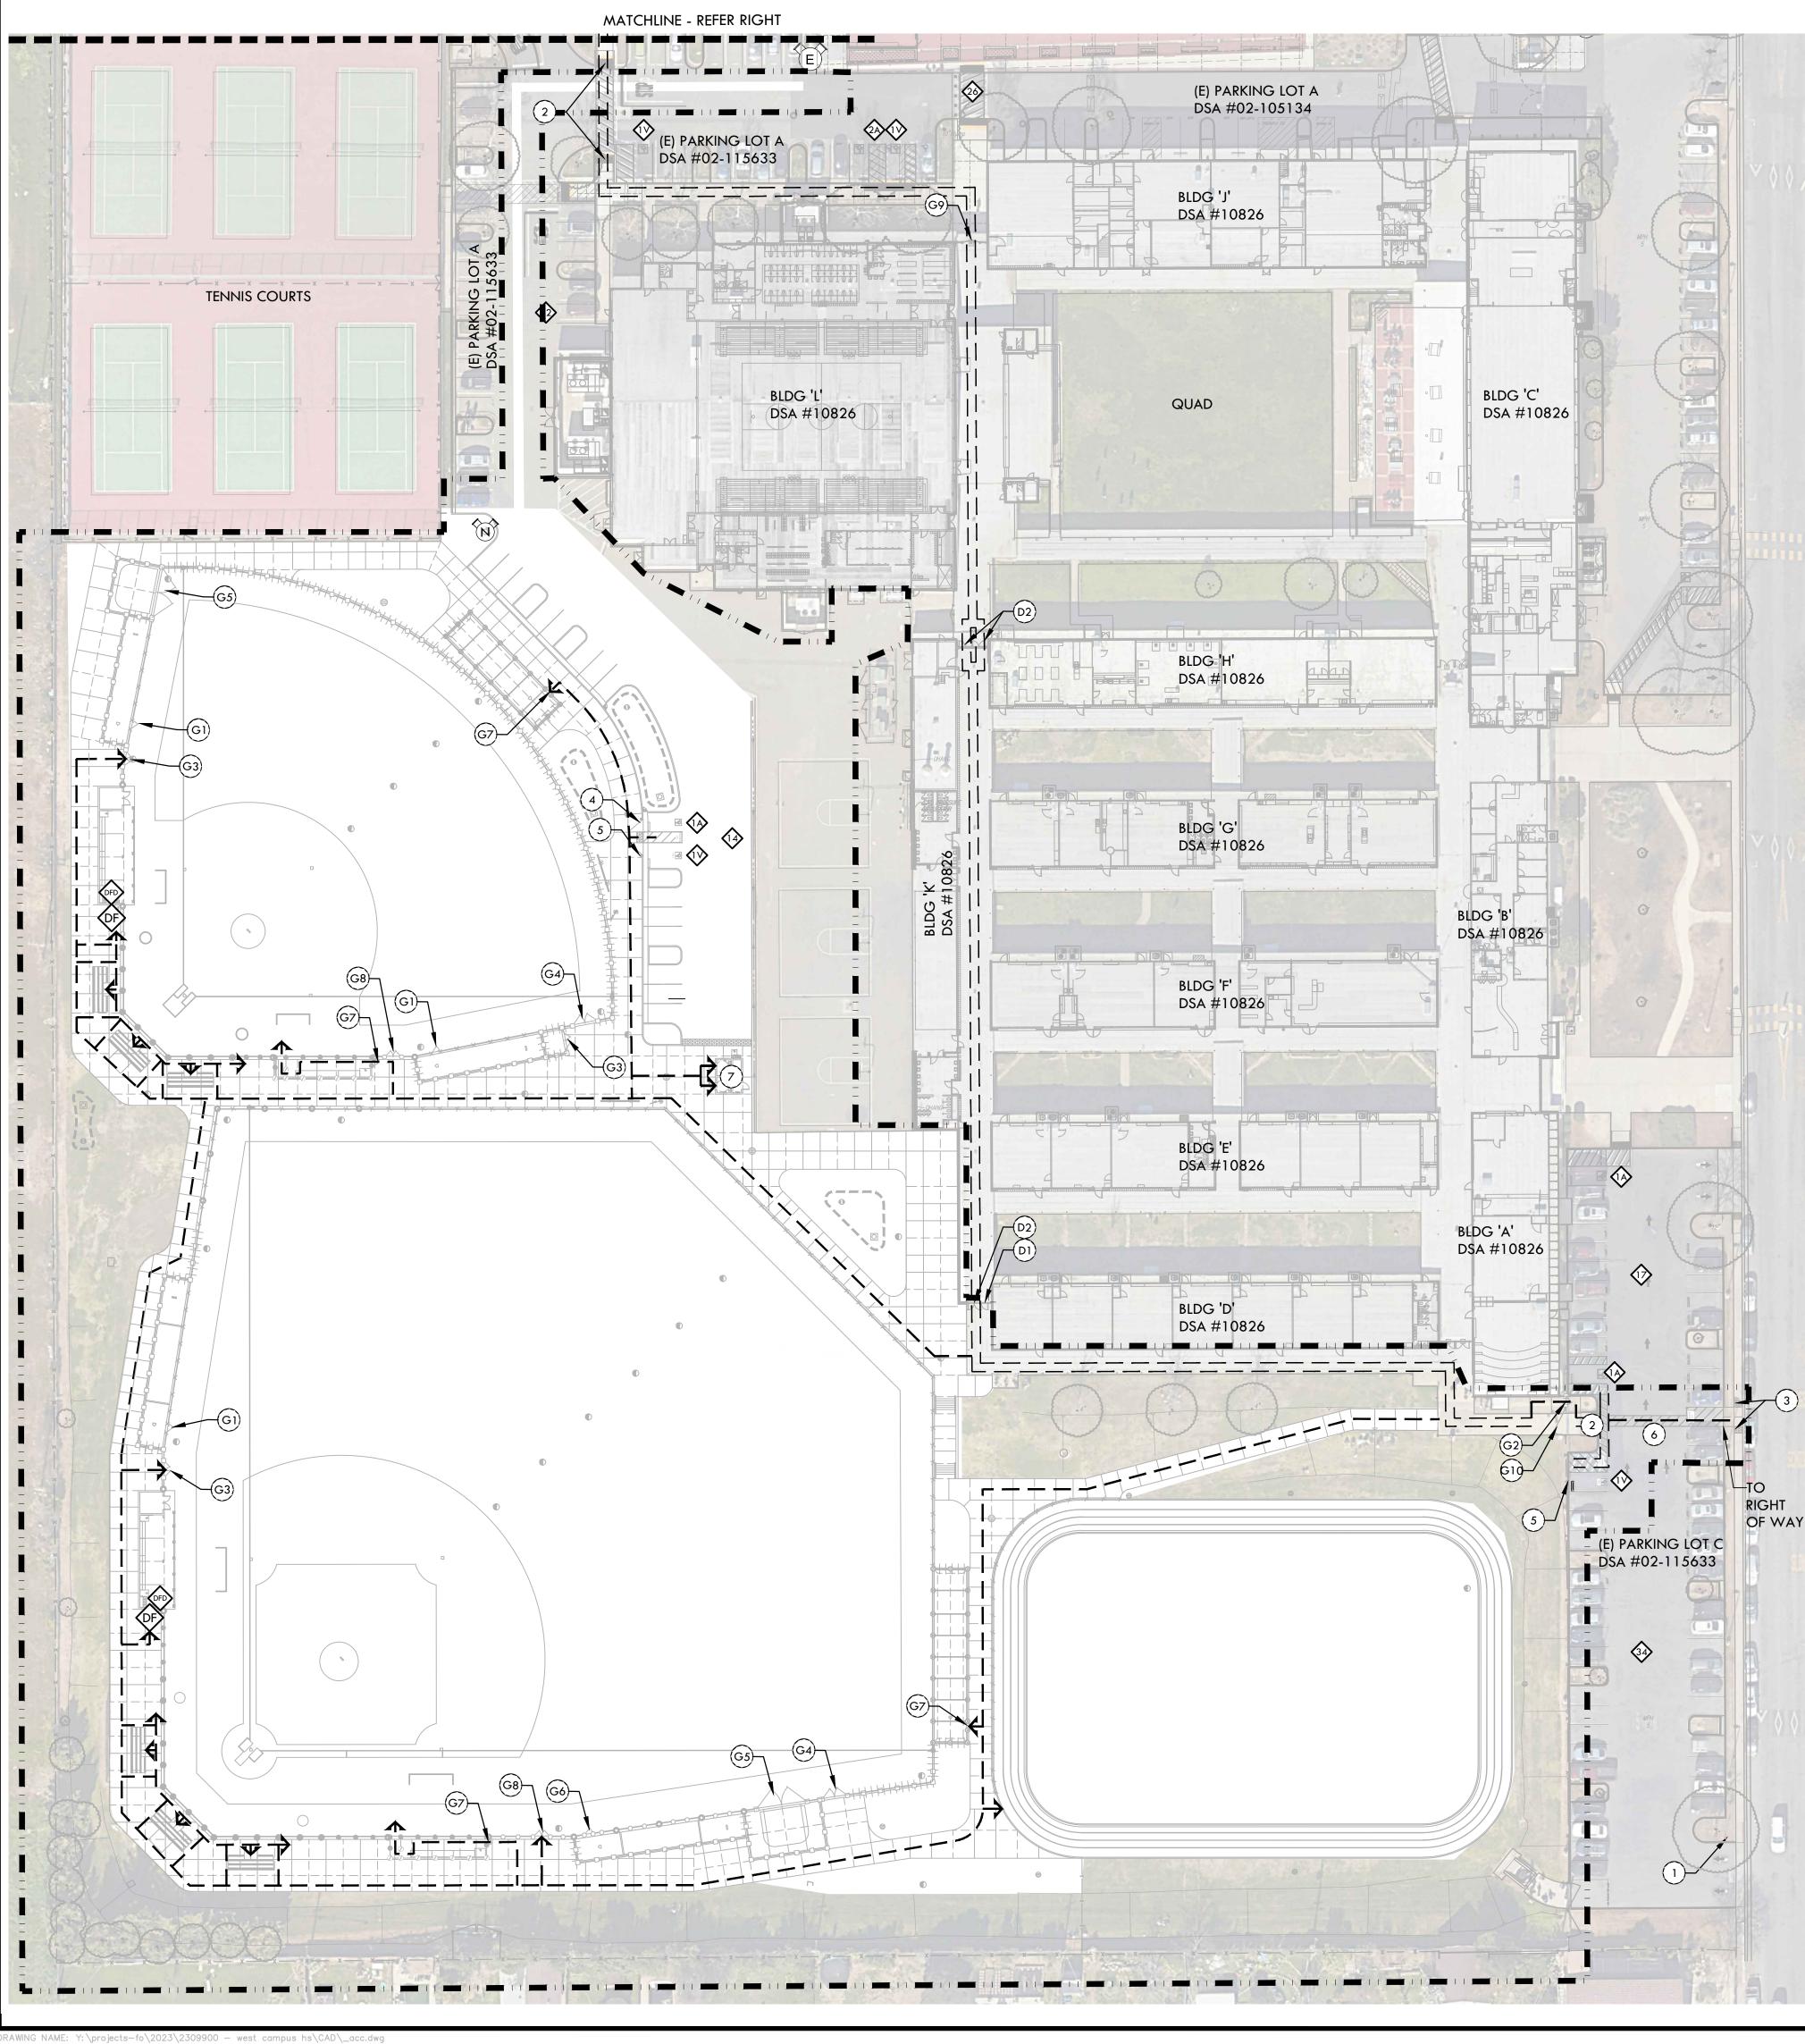ACCESSIBLE PATH OF TRAVEL AS INDICATED ON PLAN IS A BARRIER-FREE ACCESS ROUTE WITHOUT ANY ABRUPT LEVEL CHANGES EXCEEDING 1/2" BEVELED AT 1:2 MAXIMUM SLOPE, OR VERTICAL LEVEL CHANGES NOT EXCEEDING 1/4" MAXIMUM, AND IS AT LEAST 48" WIDE. SURFACE IS SLIP-RESISTANT, STABLE, FIRM, AND SMOOTH. CROSS SLOPE DOES NOT EXCEED 2%, AND SLOPE IN THE DIRECTION OF TRAVEL IS LESS THAN 5% UNLESS OTHERWISE NOTED. ACCESSIBLE PATH OF TRAVEL SHALL BE MAINTAINED FREE OF OVERHANGING OBSTRUCTIONS TO 80" MINIMUM AND FROM OBJECTS PROTRUDING MORE THAN 4" FROM WALL BETWEEN 27" AND 80" AFF. ARCHITECT SHALL VERIFY

- THAT THERE ARE NO BARRIERS IN THE PATH OF TRAVEL. CONTRACTOR SHALL VERIFY THAT ALL BARRIERS IN THE PATH OF TRAVEL HAVE BEEN REMOVED, OR WILL BE REMOVED, UNDER THIS PROJECT, AND THAT THE PATH OF TRAVEL COMPLIES WITH CBC SECTION 11B.
- CONTRACTOR TO ENSURE ACCESS THROUGH CAMPUS BY PROVIDING STRATEGIC CONSTRUCTION FENCING AND TRENCH LIDS AT APPROPRIATE LOCATIONS. VERIFY LOCATIONS WITH OWNER REPRESENTATIVE. SCHEDULE TRENCHING TO BE COMPLETED DURING PERIODS OF LEAST INTERRUPTION FOR CAMPUS USE.
- THE INTENT OF THE DRAWINGS AND SPECIFICATIONS IS TO MODIFY THE FACILITY FOR ACCESSIBILITY IN ACCORDANCE WITH TITLE 24, CALIFORNIA CODE OF REGULATIONS. SHOULD ANY CONDITIONS DEVELOP THAT ARE NOT COVERED BY THE CONTRACT DOCUMENTS SUCH THAT THE FINISHED WORK WILL NOT COMPLY WITH TITLE 24, A CONSTRUCTION CHANGE DIRECTIVE (CCD) DETAILING AND SPECIFYING THE WORK REQUIRED TO BRING CONDITIONS INTO COMPLIANCE WITH TITLE 24 SHALL BE SUBMITTED TO AND APPROVED BY DSA BEFORE PROCEEDING WITH THE WORK.

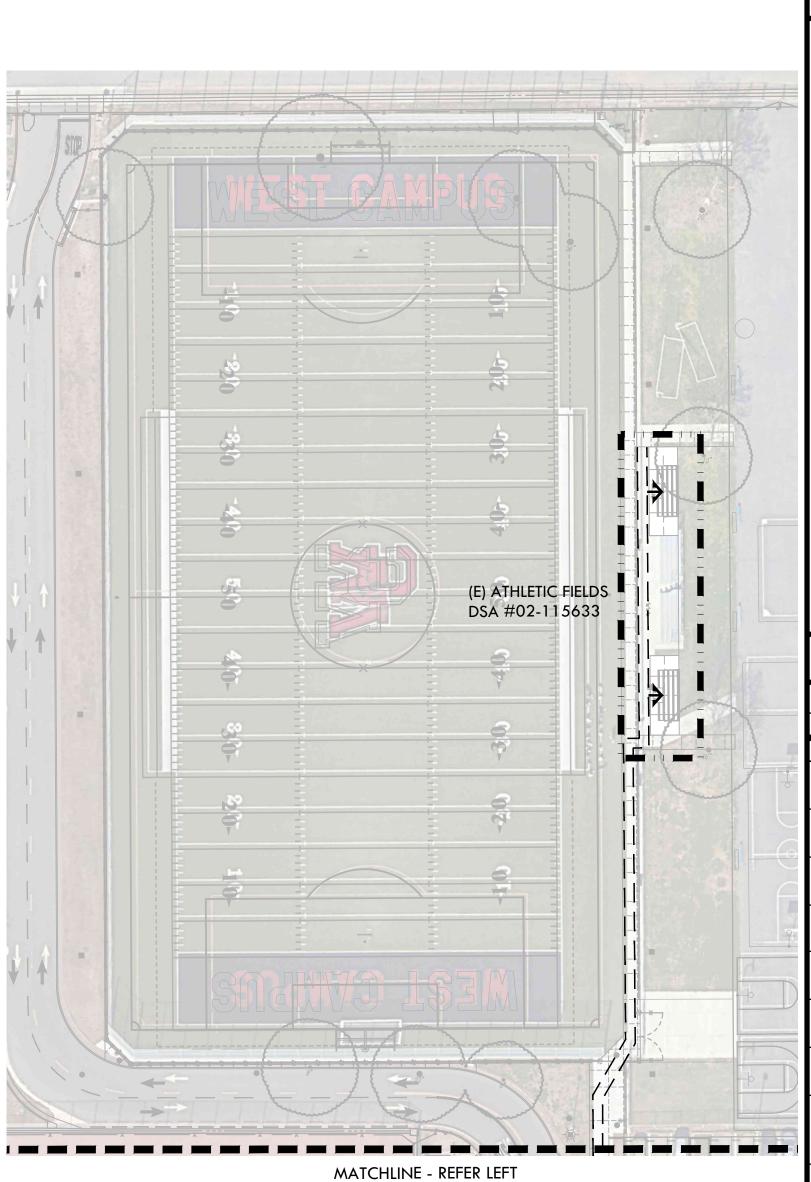DESIGN PROFESSIONAL IN GENERAL RESPONSIBLE CHARGE STATEMENT: THE POT IDENTIFIED IN THESE CONSTRUCTION DOCUMENTS IS COMPLIANT WITH CURRENT APPLICABLE


CALIFORNIA BUILDING CODE ACCESSIBILITY PROVISIONS FOR PATH OF TRAVEL REQUIREMENTS AND STRUCTURAL REPAIRS. AS PART OF THE DESIGN OF THIS PROJECT, THE POT WAS EXAMINED AND ANY ELEMENTS, COMPONENTS OR PORTION OF THE POT THAT WERE DETERMINED TO BE NONCOMPLIANT 1) HAVE BEEN IDENTIFIED AND 2) THE CORRECTIVE WORK NECESSARY TO BRING THEM INTO COMPLIANCE HAS BEEN INCLUDED WITHIN THE SCOPE OF THIS PROJECT'S WORK THROUGH DETAILS, DRAWINGS AND SPECIFICATIONS INCORPORATED INTO THESE CONSTRUCTION DOCUMENTS. ANY NONCOMPLIANT ELEMENTS, COMPONENTS OR PORTION OF THE POT THAT WILL NOT BE CORRECTED BY THIS PROJECT BASED ON VALUATION THRESHOLD LIMITATIONS OR A FINDING OF UNREASONABLE HARDSHIP ARE SO INDICATED IN THESE CONSTRUCTION DOCUMENTS.


DURING CONSTRUCTION, IF POT ITEMS WITHIN THE SCOPE OF THE PROJECT REPRESENTED AS CODE COMPLIANT ARE FOUND TO BE NONCONFORMING BEYOND REASONABLE CONSTRUCTION TOLERANCES, THEY SHALL BE BROUGHT INTO COMPLIANCE WITH THE CBC AS PART OF THIS PROJECT BY MEANS OF A "CONSTRUCTION CHANGE DOCUMENT" (FORM **DSA 140**).


| | ACCESSIBILITY LEGEND | | | | | | | | |
|----------------------|--|--|--|--|--|--|--|--|--|
| SYM | DESCRIPTION | | | | | | | | |
| | PROJECT LIMIT OF WORK | | | | | | | | |
| $\equiv \Rightarrow$ | EXISTING PEDESTRIAN ACCESS (02-115633, 110113 & 105134) | | | | | | | | |
| > | PROPOSED PEDESTRIAN ACCESS | | | | | | | | |
| DFD | PROPOSED DRINKING FOUNTAIN - WALL MOUNT @ DUGOUT | | | | | | | | |
| OF | PROPOSED DRINKING FOUNTAIN - PEDESTAL | | | | | | | | |
| E | EXISTING FIRE HYDRANT | | | | | | | | |
| | PROPOSED FIRE HYDRANT | | | | | | | | |
| #A | ACCESSIBLE PARKING STALLS (DSA 02-115633/105134). THE IOR SHALL INSPEC AND VERIFY THE EXISTING CONDITIONS ARE COMPLIANT. IF NOT COMPLIANT CONTRACTOR SHALL MAKE CORRECTIONS TO BRING THEM TO CURRENT CODE. | Т | | | | | | | |
| # | ACCESSIBLE VAN PARKING STALLS (DSA 02-115633/105134). THE IOR SHALL INSPECT AND VERIFY THE EXISTING CONDITIONS ARE COMPLIANT. IF NOT COMPLIANT CONTRACTOR SHALL MAKE CORRECTIONS TO BRING THEM TO CURRENT CODE. | | | | | | | | |
| #> | NUMBER OF EXISTING PARKING STALLS (DSA 02-115633/02-105134) | | | | | | | | |
| | EXISTING TOW AWAY SIGN | | | | | | | | |
| 2 | EXISTING TRUNCATED DOMES | | | | | | | | |
| 3 | PROPOSED TRUNCATED DOMES | | | | | | | | |
| 4 | ACCESSIBLE PARKING STALL SIGN | | | | | | | | |
| 5 | ACCESSIBLE PARKING STALL SIGN - VAN | | | | | | | | |
| 6 | CROSSWALK | | | | | | | | |
| 7 | PROPOSED RESTROOM BUILDING, REFER TO ROMTEC PLANS (BUILDING RR) | | | | | | | | |
| (D1) | EXISTING ACCESSIBLE DOOR | | | | | | | | |
| (D2) | EXISTING ACCESSIBLE DOUBLE DOOR | | | | | | | | |
| (G1) | 42" TALL x 4' WIDE CHAIN LINK SWING GATE - ACCESSIBLE | | | | | | | | |
| (G2) | 6' TALL x 4' WIDE SWING GATE WITH PANIC HARDWARE | 6' TALL x 4' WIDE SWING GATE WITH PANIC HARDWARE | | | | | | | |
| G 3 | 6' TALL x 4' WIDE DOUBLE SWING GATE WITH PANIC HARDWARE | | | | | | | | |
| (G4) | 6' TALL x 12' WIDE DOUBLE SWING GATE (WITH OR WITHOUT SLATS) | | | | | | | | |
| (G5) | 6' TALL x 24' WIDE DOUBLE SWING GATE | | | | | | | | |
| G6 | 8' TALL x 4' WIDE CHAIN LINK SWING GATE WITH NETTING | _ | | | | | | | |
| (G7) | 8' TALL x 4' WIDE CHAIN LINK SWING GATE WITH TRANSOM | | | | | | | | |
| 68 | 8' TALL x 4' WIDE DOUBLE SWING GATE WITH PANIC HARDWARE | | | | | | | | |
| G 9 | EXISTING ACCESSIBLE GATE - THE IOR SHALL INSPECT AND VERIFY THE EXISTING CONDITIONS ARE COMPLIANT. IF NOT COMPLIANT CONTRACTOR SHALL MAKE CORRECTIONS TO BRING THEM TO CURRENT CODE. | | | | | | | | |
| G10 | EXISTING MAINTENANCE GATE | | | | | | | | |
| | PARKING COUNTS | | | | | | | | |
| TOTAL (e) | (e) | ٩R | | | | | | | |
| | AT LOT A (DSA # 02-115633) | | | | | | | | |
| 66 | 62 2 2 2 1 | | | | | | | | |
| | · · · · · · · · · · · · · · · · · · · | | | | | | | | |

PARKING AT LOT C (DSA # 02-115633)

THE IOR SHALL INSPECT AND VERIFY THE EXISTING CONDITIONS ARE COMPLIANT. IF NOT

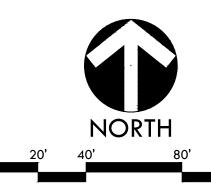

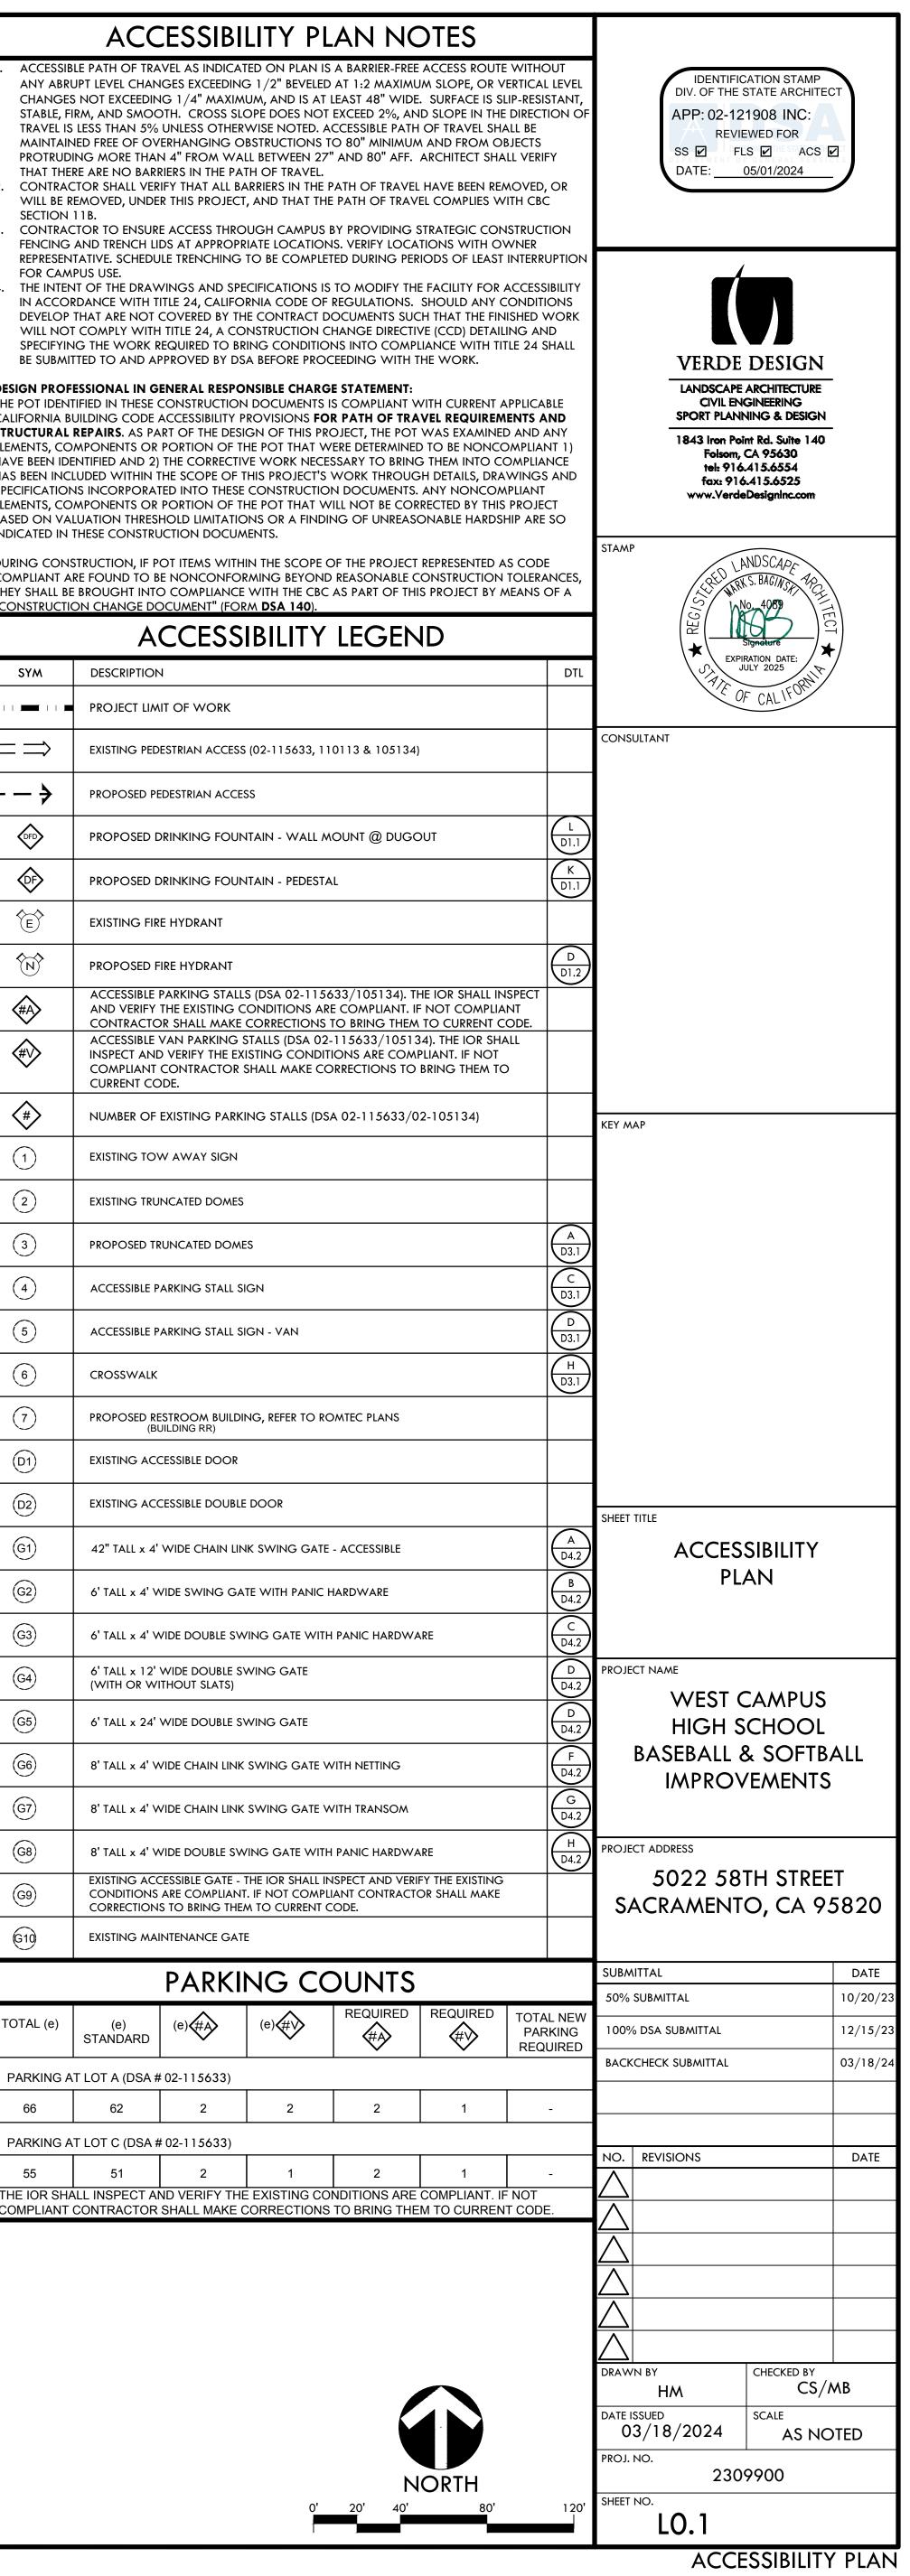

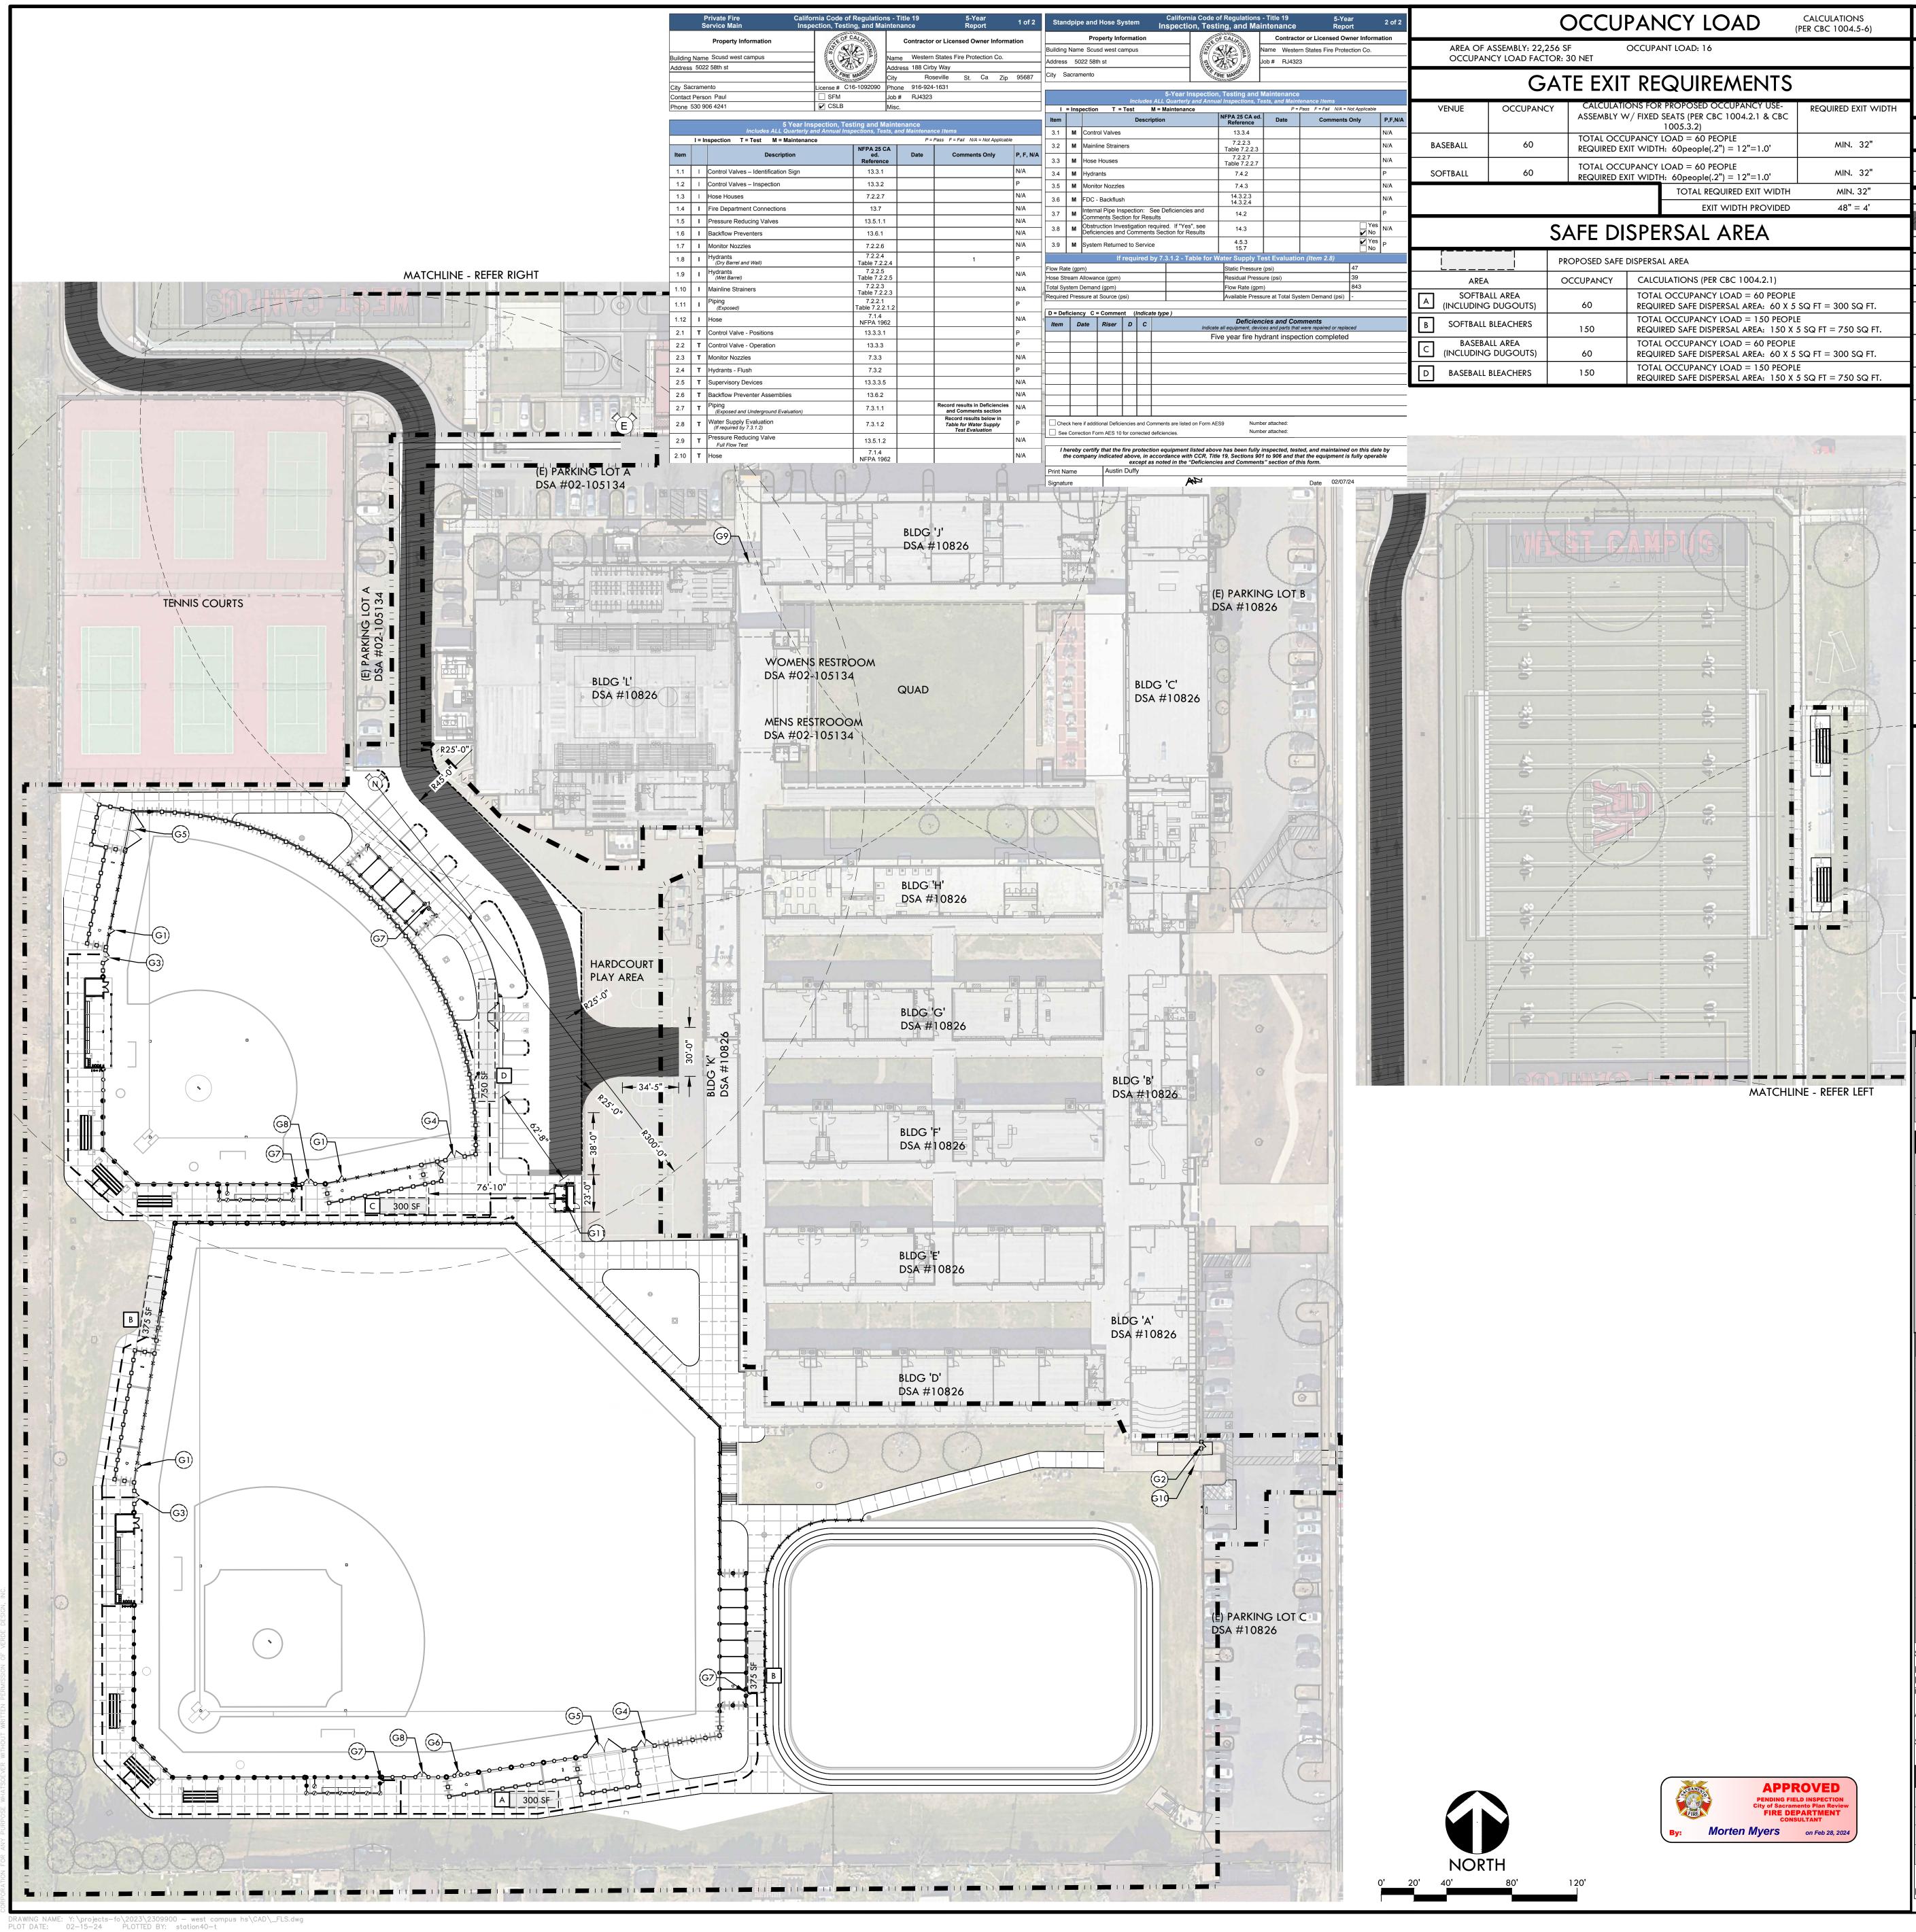

| OCCUPANCY LOAD CALCULATIONS (PER CBC 1004.5-6) | | | | FIRE/LIFE SAFETY PLAN NOTES |
|---|---|----------------------|-------------|---|
| 6 SF R: 30 NET | OCCUPANT LOAD: 16 | | | IT OF THE DRAWINGS AND SPECIFICATIONS IS TO MODIFY THE FACILITY FOR ACCESSIBILITY IN ANCE WITH TITLE 24, CALIFORNIA CODE OF REGULATIONS. SHOULD ANY CONDITIONS DEVELO |
| | | | ARE NOT | COVERED BY THE CONTRACT DOCUMENTS SUCH THAT THE FINISHED WORK WILL NOT COMPLY |
| | F REQUIREMENTS | | BRING CC | A CONSTRUCTION CHANGE DIRECTIVE (CCD) DETAILING AND SPECIFYING THE WORK REQUIRED ONDITIONS INTO COMPLIANCE WITH TITLE 24 SHALL BE SUBMITTED TO AND APPROVED BY DSA I |
| | ONS FOR PROPOSED OCCUPANCY USE- V/ FIXED SEATS (PER CBC 1004.2.1 & CBC | REQUIRED EXIT WIDTH | | ING WITH THE WORK. AWING IS FOR AGENCY APPROVAL ONLY - NOT FOR CONSTRUCTION. |
| | 1005.3.2) | | | FIRE, LIFE & SAFETY LEGEND |
| | UPANCY LOAD = 60 PEOPLE XIT WIDTH: 60people(.2") = 12"=1.0' | MIN. 32" | | |
| | | MIN. 32" | SYM | DESCRIPTION |
| | XIT WIDTH: 60people(.2") = 12"=1.0' TOTAL REQUIRED EXIT WIDTH | MIN. 32" | | PROJECT LIMIT OF WORK |
| | EXIT WIDTH PROVIDED | 48" = 4' | | EXISTING FIRE DEPARTMENT ACCESS (02-120928)- ROUTE IS TO BE A MIN 20' WIDE BY 14' |
| | SPERSAL AREA | | | VERTICAL CLEARANCE AND RATED 96,000LBS. VEHICLE BARRIER GATES SHALL BE PROVIDED WITH A KNOX BOX. |
| | | | | SAFE DISPERSAL ROUTE |
| PROPOSED SAFE | DISPERSAL AREA | | | |
| OCCUPANCY | CALCULATIONS (PER CBC 1004.2.1) | | | CURB/ROADWAY SHALL BE PAINTED RED AND CLEARLY MARKED WITH THE WORDS IN WHITE PAINT "FIRE LANE – NO PARKING CVC 22500.1" (REFER ALSO TOSPECIFICATIONS |
| 60 | TOTAL OCCUPANCY LOAD = 60 PEOPLE REQUIRED SAFE DISPERSAL AREA: 60 X 5 | | | AND DSA PL 07-03 FOR MORE INFORMATION) |
| 150 | TOTAL OCCUPANCY LOAD = 150 PEOPL REQUIRED SAFE DISPERSAL AREA: 150 X | | É. | EXISTING FIRE HYDRANT |
| 60 | TOTAL OCCUPANCY LOAD = 60 PEOPLE | | | PROPOSED FIRE HYDRANT |
| 150 | REQUIRED SAFE DISPERSAL AREA: 60 X 5 TOTAL OCCUPANCY LOAD = 150 PEOPL | E | | |
| 130 | REQUIRED SAFE DISPERSAL AREA: 150 X | 5 SQ FT = 750 SQ FT. | GI | 42" TALL x 4' WIDE CHAIN LINK SWING GATE - ACCESSIBLE |
| | | | G2) | 6' TALL x 4' WIDE SWING GATE WITH PANIC HARDWARE |
| | | | G3) | 6' TALL x 4' WIDE DOUBLE SWING GATE WITH PANIC HARDWARE |
| | | | G4 | 6' TALL x 12' WIDE - DOUBLE SWING GATE (WITH OR WITHOUT SLATS) |
| | | | <u>(G5)</u> | 6' TALL x 24' WIDE DOUBLE SWING GATE |
| ST C | | | 66) | 8' TALL x 4' WIDE CHAIN LINK SWING GATE WITH NETTING |
| | | | 67) | 8' TALL x 4' WIDE CHAIN LINK SWING GATE WITH TRANSOM - ACCESSIBLE |
| | | | G8 | 8' TALL x 4' WIDE DOUBLE SWING GATE WITH PANIC HARDWARE |
| | | 15 | 69 | EXISTING ACCESSIBLE GATE- THE IOR SHALL INSPECT AND VERIFY THE EXISTING CONDITIONS ARE COMPLIANT. IF NOT COMPLIANT CONTRACTOR SHALL MAKE CORRECTIONS TO BRING THEM TO CURRENT CODE. |
| | 30 | | 610 | EXISTING MAINTENANCE GATE |
| | | | 611) | PROPOSED RESTROOM BUILDING, REFER TO ROMTEC PLANS & DETAILS |
| | | | | |

ROJECT INFORMATION School District/Owner: Sacramento City Unified School District


Project Name/School: West Campus High School Baseball & Softball Improvements


Project Address: 5022 58TH STREET, Sacramento, CA 95820


| FIU | ect Address. | | | | | |
|------------------|---|------------|---------|--------------|--------------|------|
| FIR | E & LIFE SAFETY INFORMATION | | | | | |
| 1. | Has a fire hydrant flow test been performed within the past 12 months? | Yes 🛙 | | | No 🗆 | |
| | (If yes, provide a copy of the test data.) | | | | | |
| 2. | Was the fire hydrant water flow test performed as part of this LFA review? (the fire flow provided on the Inspection, Testing and Maintenance report dated 02/07/2024) shall be deemed adequate for the type of construction and size of the proposed structures) | Yes 🛛 | | | No 🗆 | |
| 3. | Is the project located within a designated fire hazard severity zone (FHSZ) as established by Cal-Fire? (<i>If yes, indicate FHSZ classification below.</i>) | Yes □ | | | No 🗵 | |
| | Refer to the following website for FHSZ locations: http://egis.fire.ca.gov/FHSZ/ | Modera | ate 🗆 | High 🗆 | Very H | ligh |
| - | Wildland Interface Area (WIFA) (If any designations are checked, project requirements of CBC Chapter 7A.) | design r | nust m | eet the | WIFA | |
| cor | NDITION MEANS AND METHODS RESOLUTION | | ALTE | RNATE A | ССЕРТЕ | ED |
| 4. | Emergency vehicle access roadways do not meet CFC requirements. | | Yes | No | N/A | N |
| 4a. | Acceptable Alternate: Emergency vehicle and personnel access as proby the project architect is acceptable for providing fire suppression and protection of life and property. | oposed | | | | |
| 5. | Fire Hydrants: Number and spacing does not meet CFC requirements. | | | | \checkmark | |
| 5a. | Acceptable Alternate: Number of fire hydrants and spacing as propose the project architect is acceptable for fire suppression and protection of property. | | | | | |
| 6. | Fire Hydrants: Water flow and pressure are less than CFC minimum. | | | | ✓ | |
| 6a. | Acceptable Alternate: The available flow and pressure is acceptable for providing fire suppression and protection of life and property. | r | | | | |
| 7. | Location of fire department connection(s) serving fire sprinkler systems standpipe systems does not meet CFC requirements. | or | | | - | |
| 7a. | Acceptable Alternate: The location of fire department connection servin fire sprinkler system and/or standpipe system is acceptable for providing suppression and protection of life and property. | | | | | |
| Scho | ol District Acceptance of Acceptable Design Alternates | | | | | _ |
| By się Buildi | ning this form, the school district acknowledges and accepts the proposed ng Code (CBC) and California Fire Code (CFC) minimum requirements, a ted at items 4a, 5a, 6a or 7a, for providing fire and life safety protection of | s indicate | ed by c | one or more | | |
| Acce | oted by: Ralston, Chris Title: | Directo | or, Fac | cilities Mar | nageme | nt |
| Signa | ture: Chris Ralston Digitally signed by Chris Ralston Date: 2023.10.17 10:16:47 -07'00 | 'I | Date: _ | 0/17/23 | | |
| 1.00 | AL FIRE AUTHORITY (LFA) INFORMATION | <u></u> | | | | |
| | | | | | | |
| | Agency Name: Sacramento Fire Department | | | | | |
| | Review Official: King Tunson | | | 2 000 400 | =0 | |
| Title | | Drk Phon | e: 916 | 5-808-13 | ÖÖ | |
| Wor | k Email: ktunson@sfd.cityofsacramento.org | | | | | |


LFA Reviewer's Signature: King Tunson

03/01/2024 __Date:

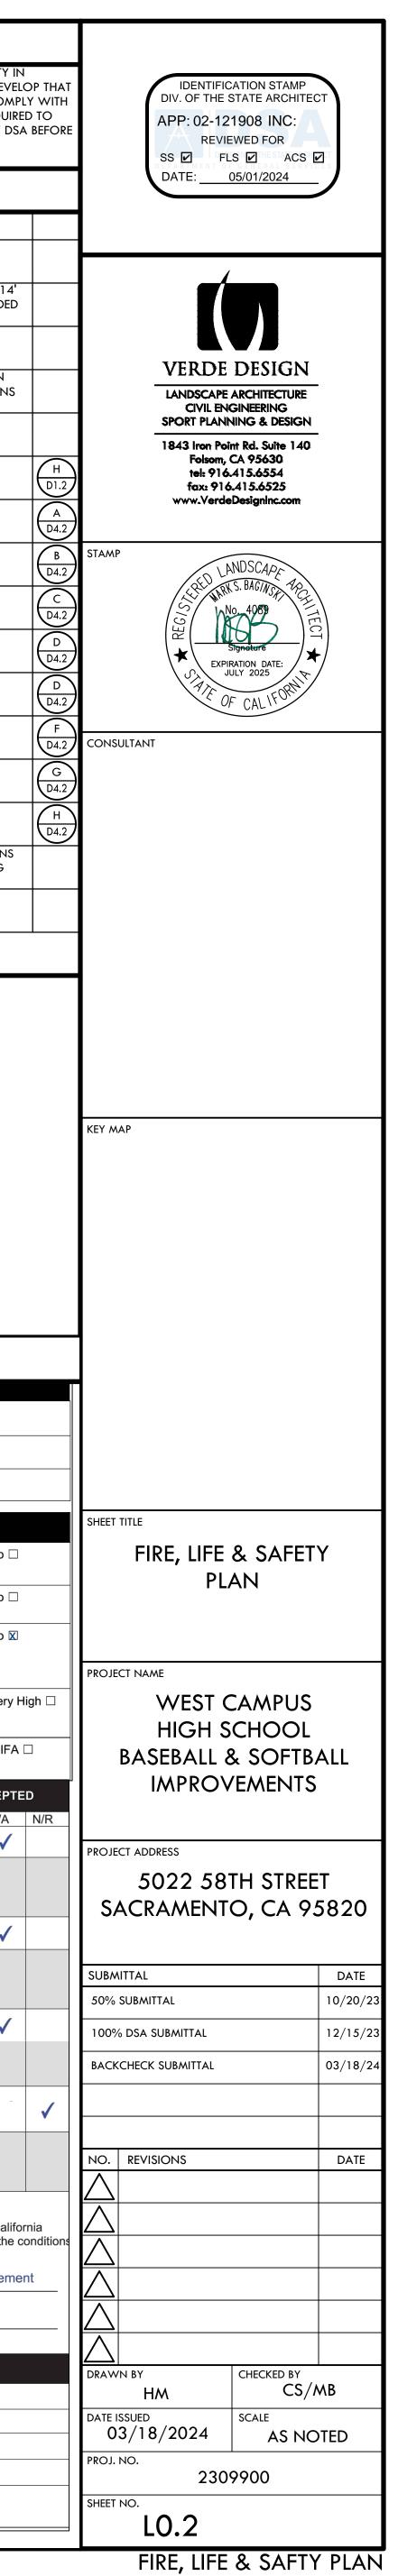

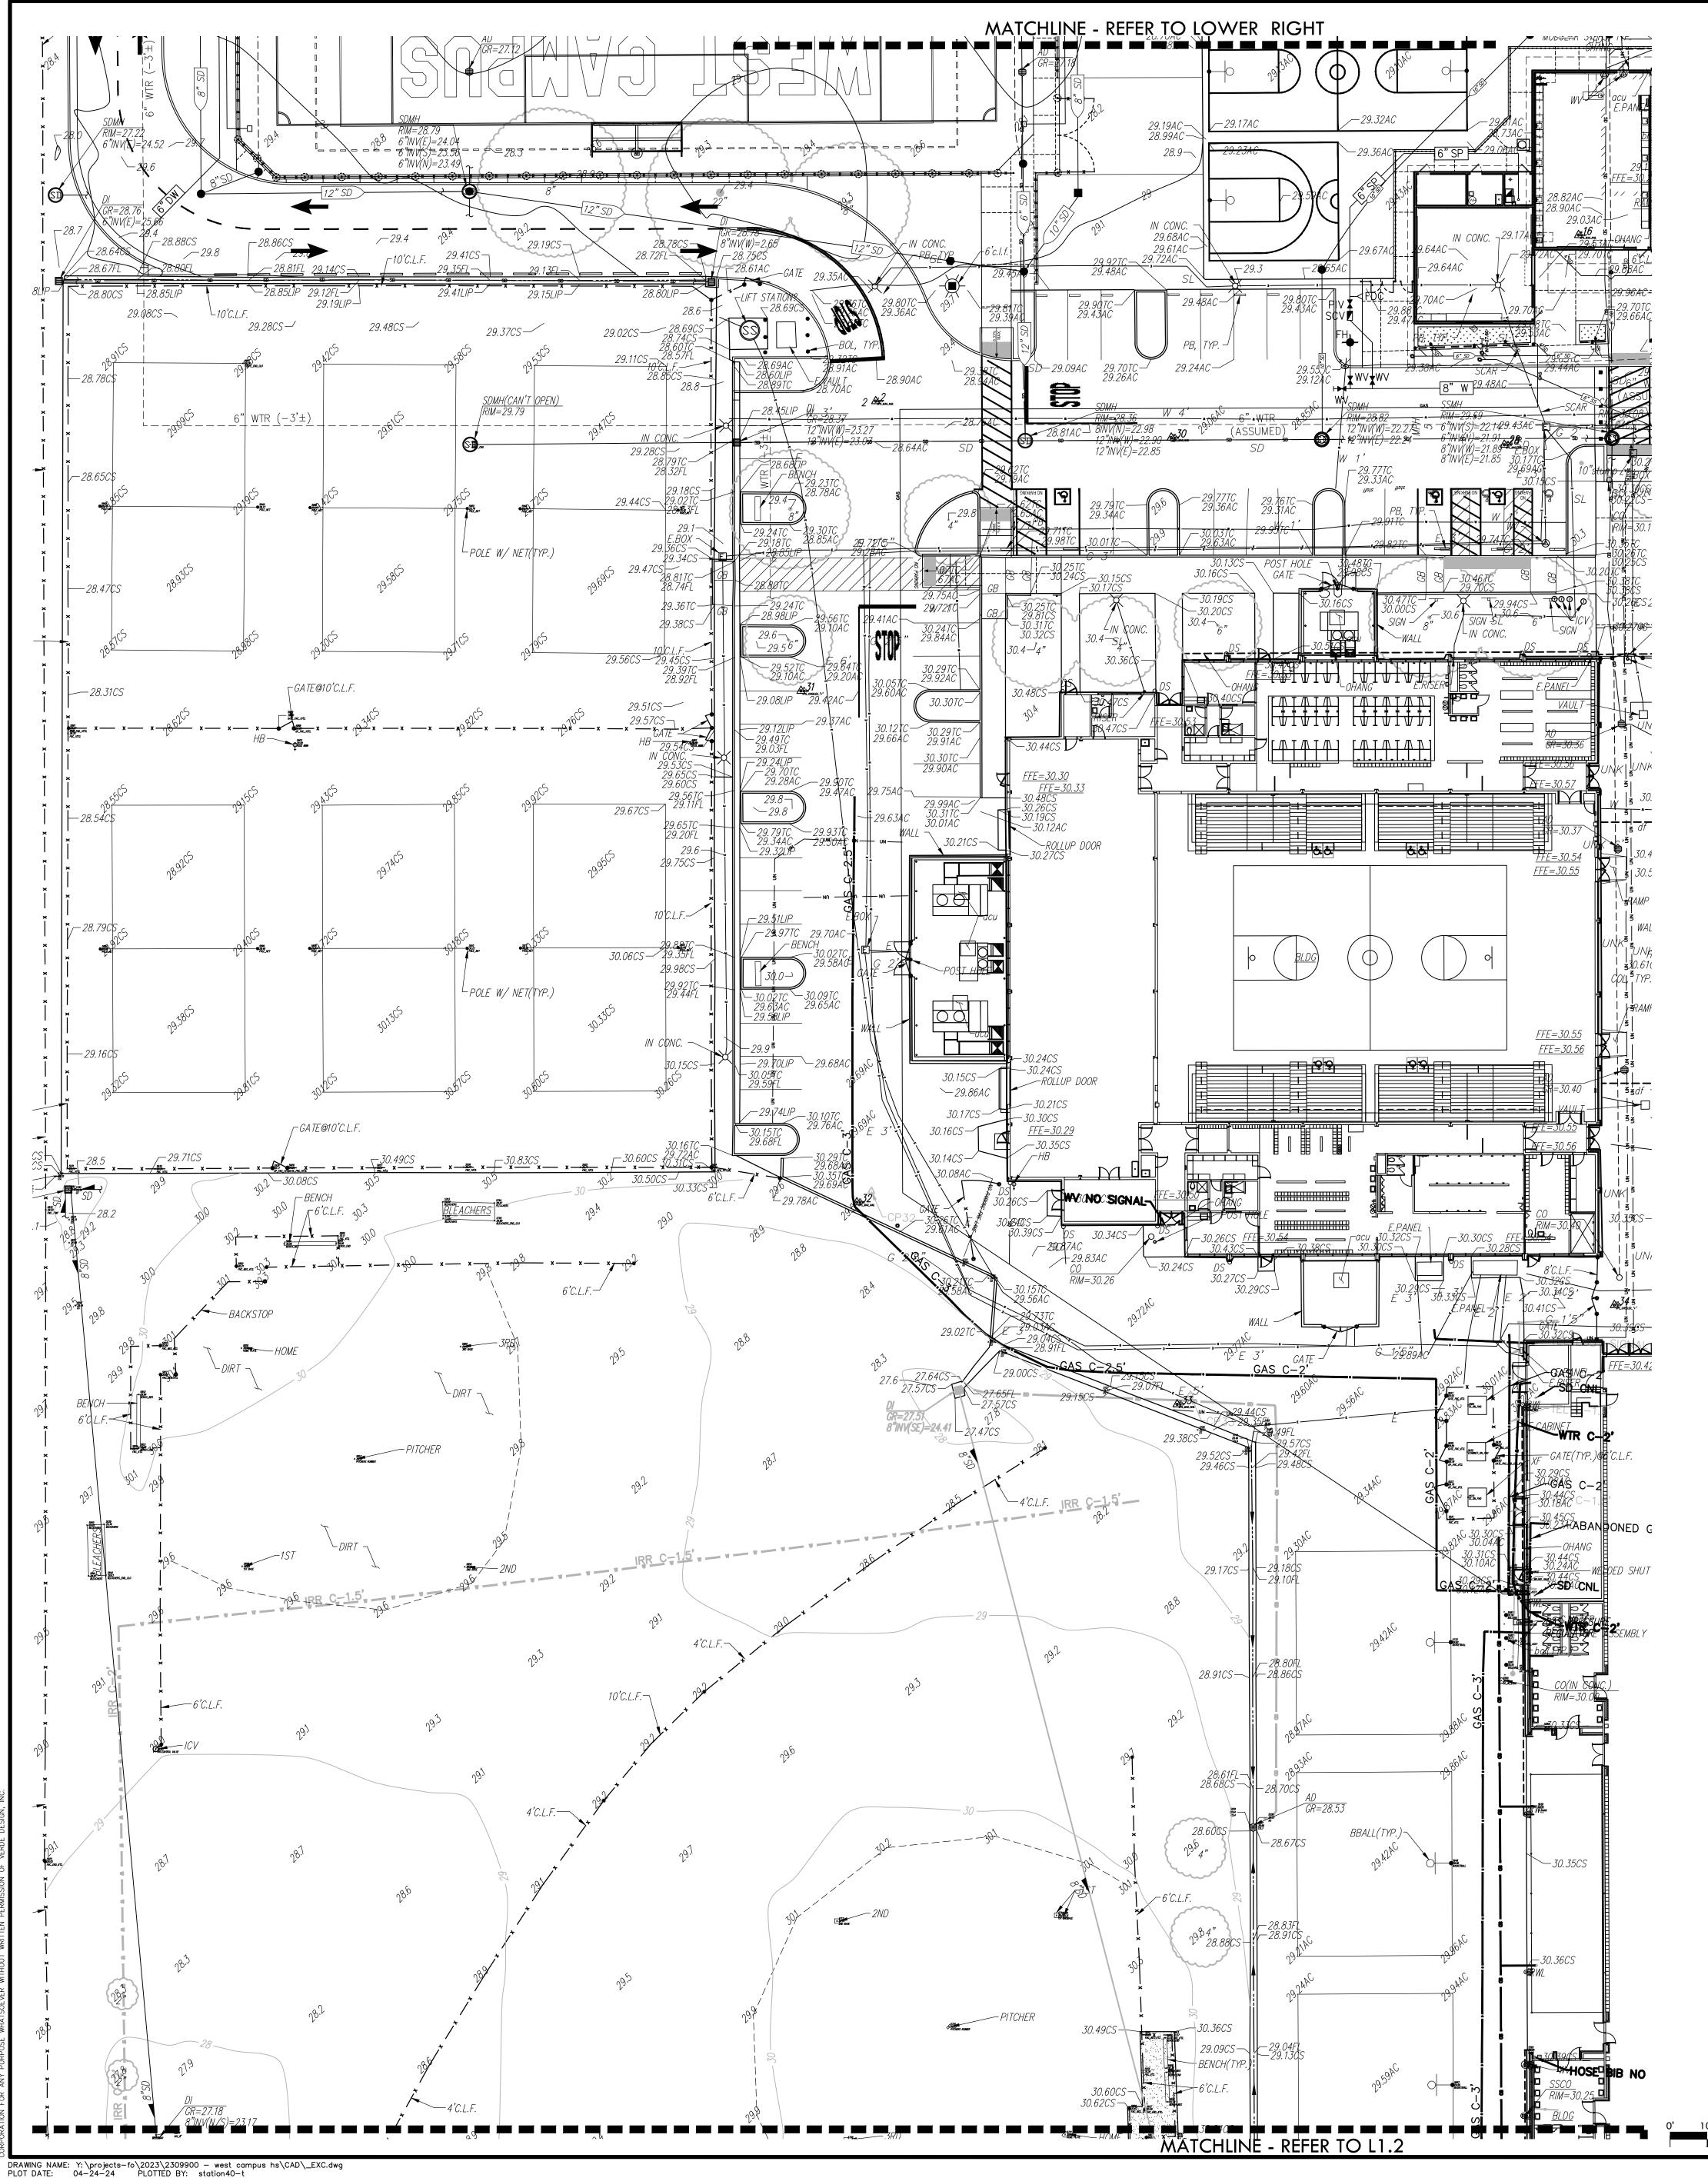

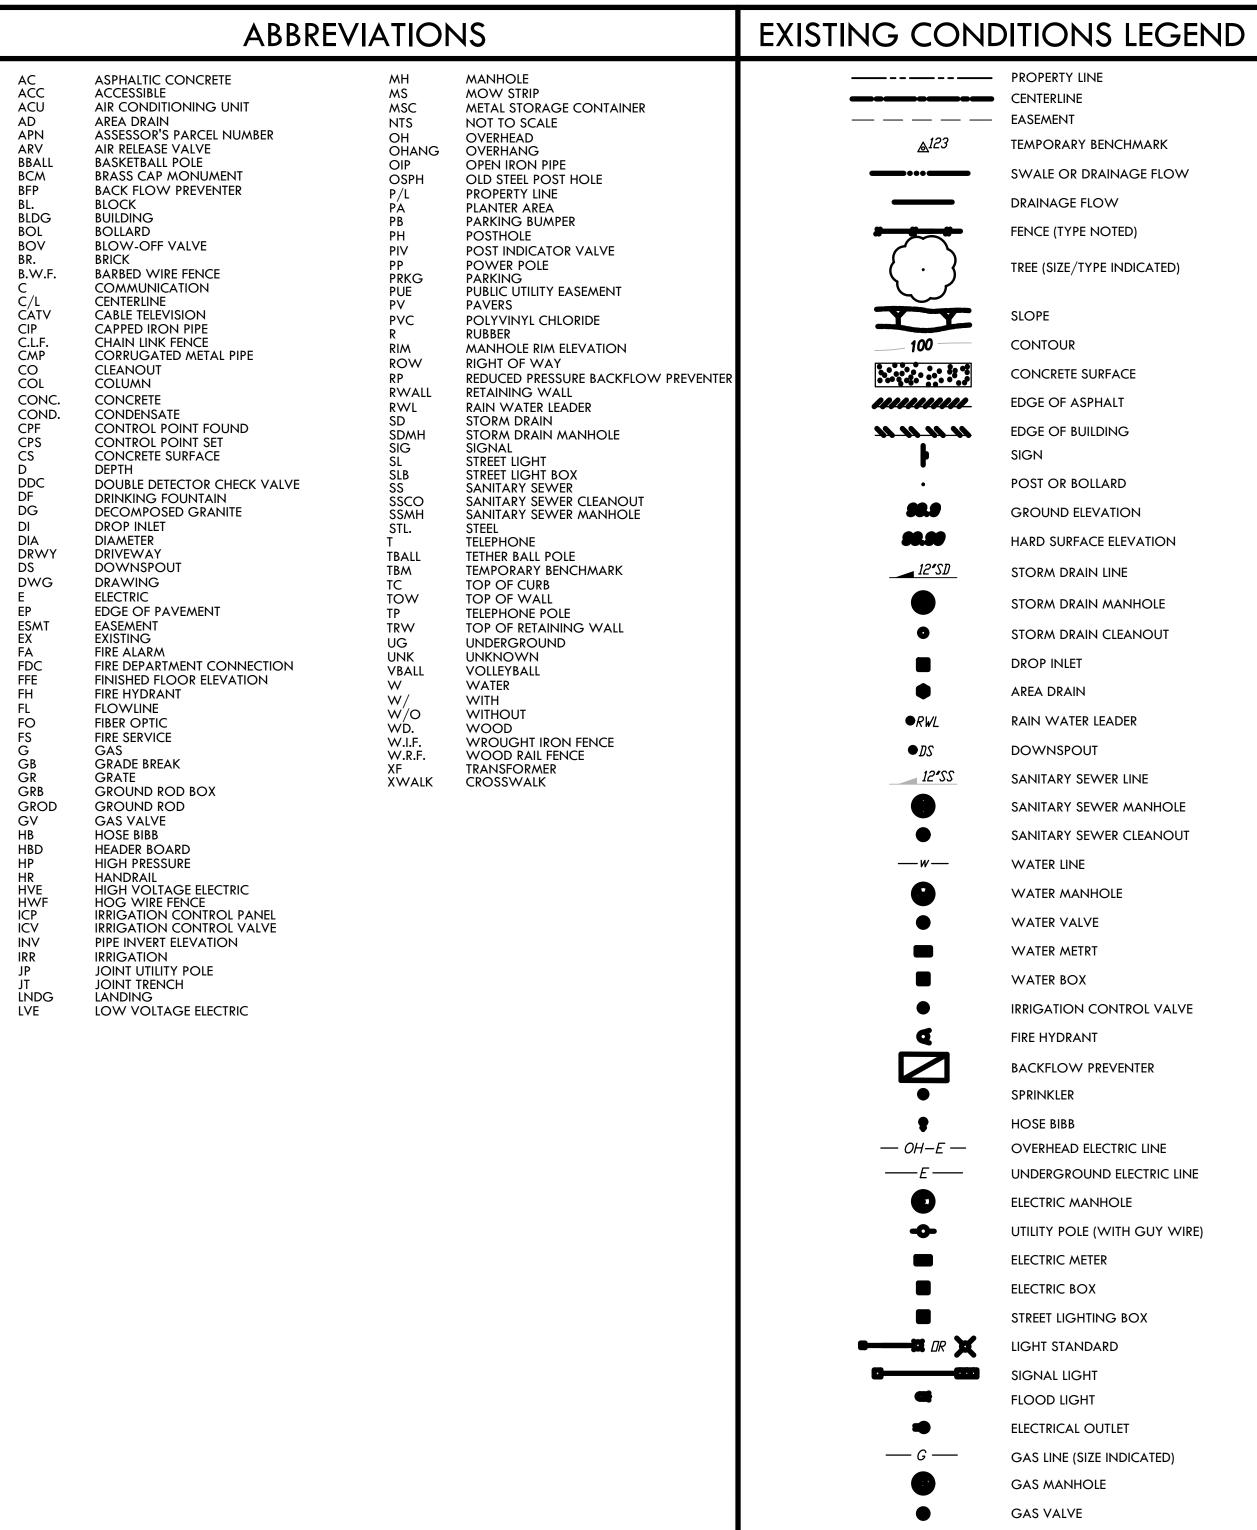

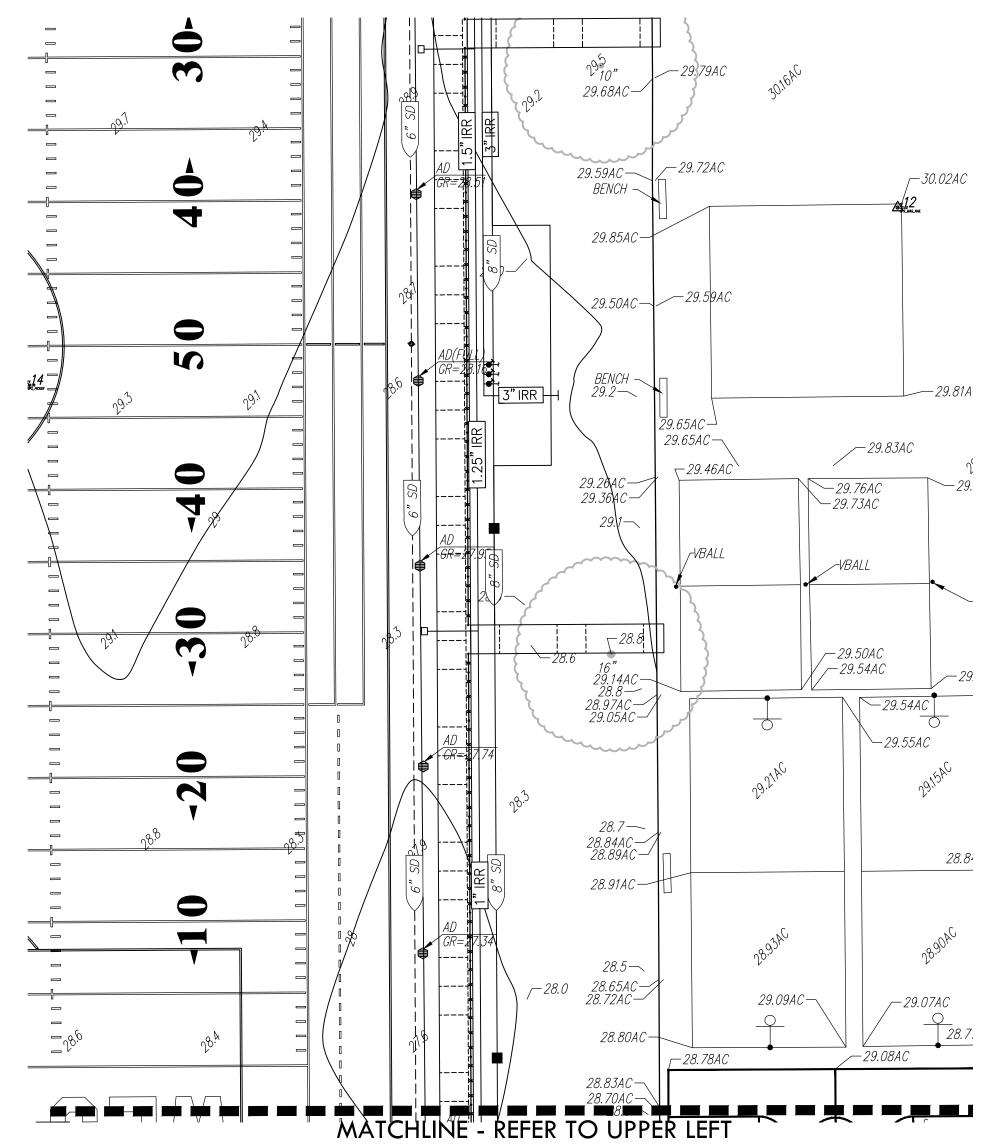


NORTH


GAS METER

TELEPHONE LINE


STORM DRAIN BOX

TRAFFIC SIGNAL BOX

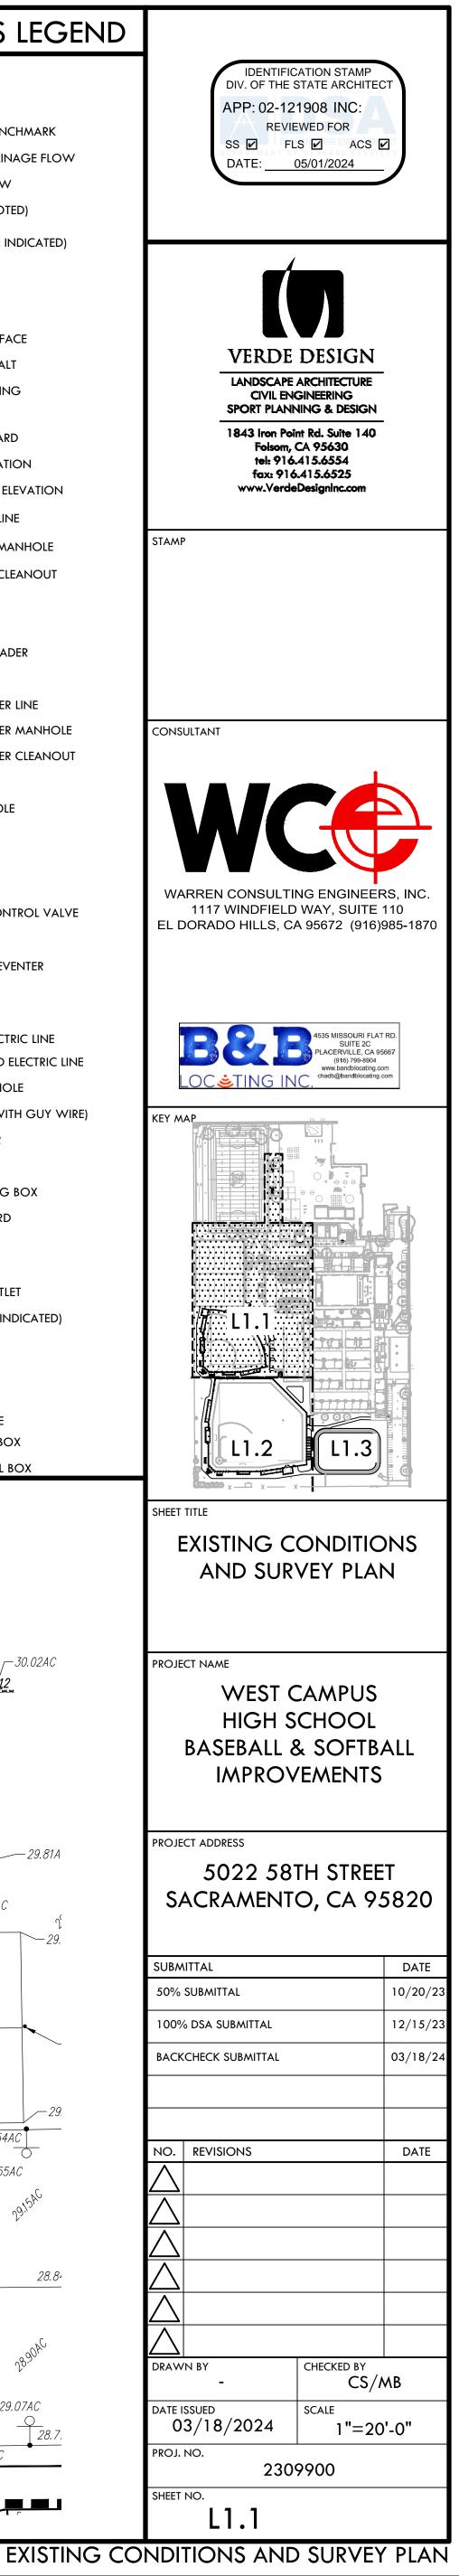


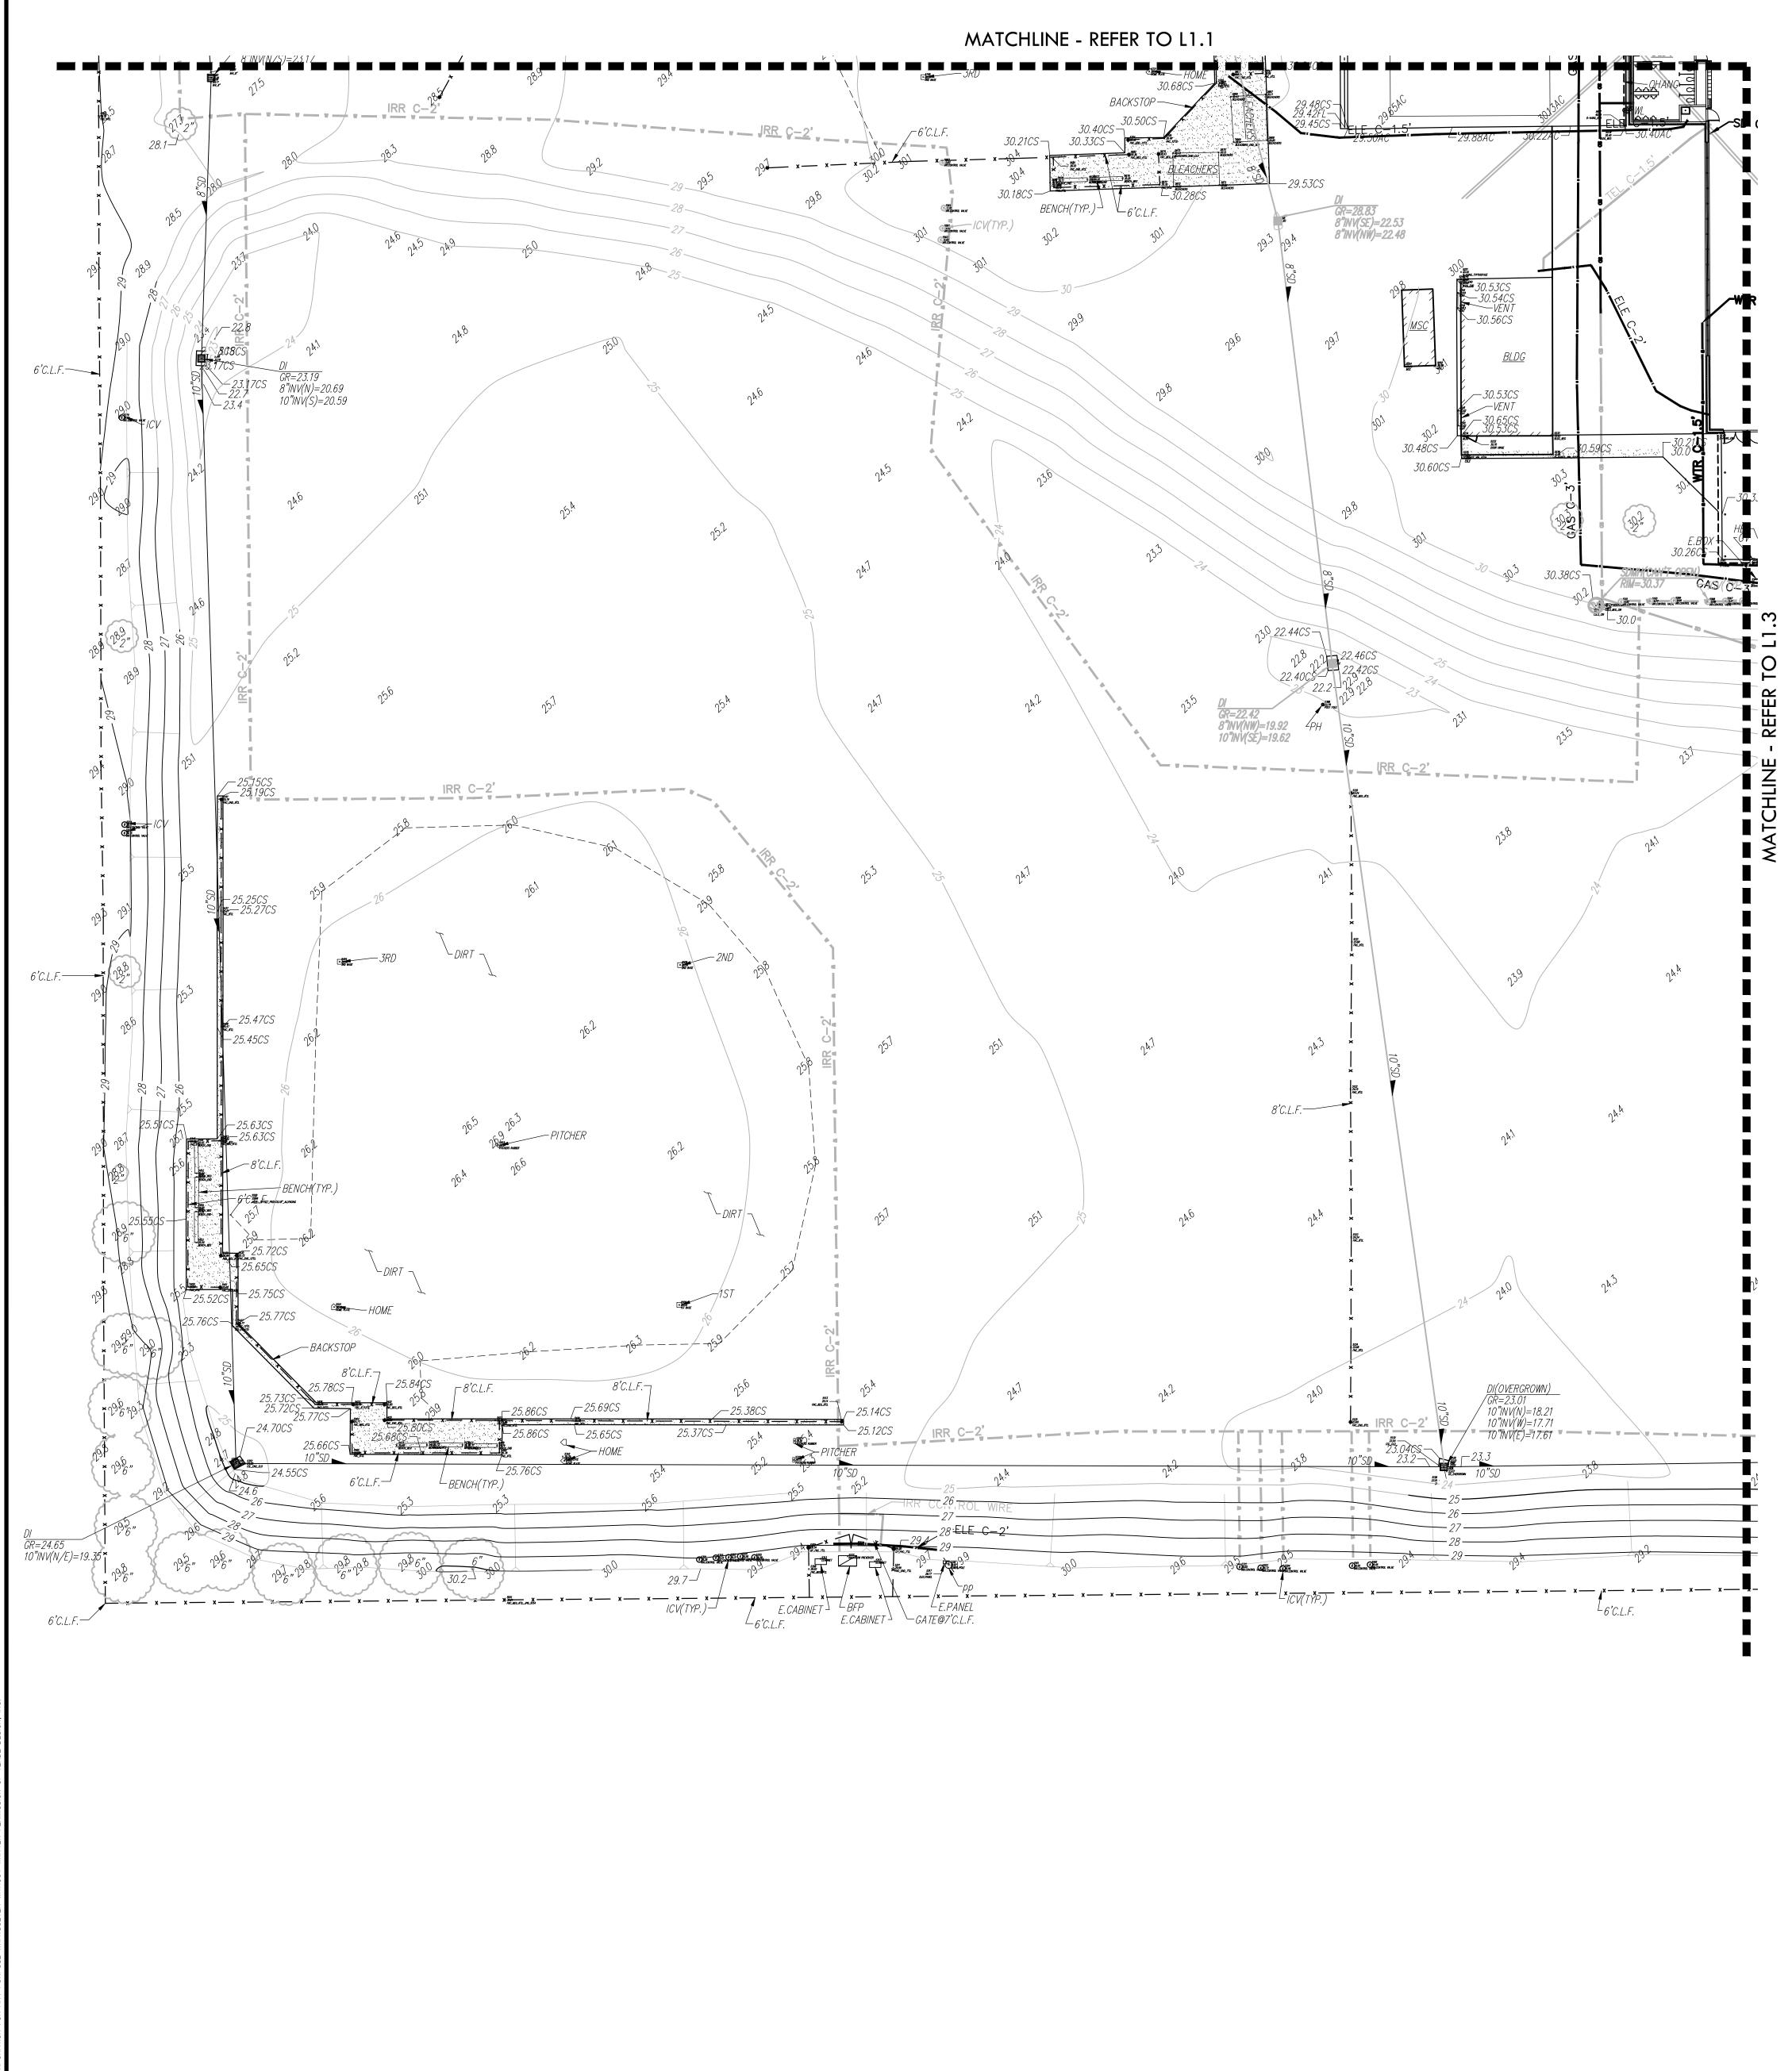


| Action of the second se | | ABBRE | | ٧S | EXISTING CON | DITIONS LEGEN |
|--|---|--|--|---|--------------|--|
| STORM DRAIN BOX | ACU AD N V BBAM BE UNDER CONTROLOGIES AND ART AND | ACCESSIBLE AIR CONDITIONING UNIT AREA DRAIN ASSESSOR'S PARCEL NUMBER AIR RELEASE VALVE BASKETBALL POLE BRASS CAP MONUMENT BACK FLOW PREVENTER BLOCK BUILDING BOLLARD BLOW-OFF VALVE BRICK BARBED WIRE FENCE COMMUNICATION CENTERLINE CABLE TELEVISION CAPPED IRON PIPE CHAIN LINK FENCE CORRUGATED METAL PIPE CLEANOUT COLUMN CONCRETE CONTROL POINT FOUND CONTROL POINT SET CONTROL POINT SET CONTROL POINT SET CONCRETE SURFACE DEPTH DOUBLE DETECTOR CHECK VALVE DRINKING FOUNTAIN DECOMPOSED GRANITE DROP INLET DIAMETER DRIVEWAY DOWNSPOUT DRAWING ELECTRIC EDGE OF PAVEMENT EASEMENT EXISTING FIRE ALARM FIRE DEPARTMENT CONNECTION FINISHED FLOOR ELEVATION FIRE HYDRANT FLOWLINE FIBER OPTIC FIRE SERVICE GAS GRADE BREAK GRATE GROUND ROD GAS VALVE HOSE BIBB HEADER BOARD HIGH PRESSURE HANDRAIL HIGH PRESSURE HANDRAIL HIGH PRENCE IRRIGATION CONTROL PANEL IRRIGATION CONTROL PANEL IRRIGATION JOINT UTILITY POLE JOINT UTILITY POLE | MS MSC NTS OH OHANG OIP OSPH P/L PA PB PH PIV PP PKG PUE PV PVC R RIM ROW RP RWALL RWL SD SDMH SIG SL SLB SS SSCO SSMH STL. T TBALL TBM TC TOW TP TRW UG UNK VBALL W V/O W/O W.F. F. XF | MOW STRIP METAL STORAGE CONTAINER NOT TO SCALE OVERHEAD OVERHEAD OVERHANG OPEN IRON PIPE OLD STEEL POST HOLE PROPERTY LINE PLANTER AREA PARKING BUMPER POST INDICATOR VALVE POWER POLE PARKING PUBLIC UTILITY EASEMENT PAVERS POLYVINYL CHLORIDE RUBBER MANHOLE RIM ELEVATION RIGHT OF WAY REDUCED PRESSURE BACKFLOW PREVENTER RETAINING WALL RAIN WATER LEADER STORM DRAIN STORM DRAIN MANHOLE SIGNAL STREET LIGHT BOX SANITARY SEWER CLEANOUT SANITARY SEWER MANHOLE SIGNAL STREET LIGHT BOX SANITARY SEWER MANHOLE STEEL TELEPHONE TETHER BALL POLE TEMPORARY BENCHMARK TOP OF CURB TOP OF WALL TELEPHONE POLE TOP OF RETAINING WALL UNDERGROUND UNKNOWN VOLLEYBALL WATER WITH WITHOUT WOOD WROUGHT IRON FENCE WOOD RAIL FENCE TRANSFORMER | | CENTERLINE EASEMENT TEMPORARY BENCHMARK SWALE OR DRAINAGE FLOW DRAINAGE FLOW FENCE (TYPE NOTED) TREE (SIZE/TYPE INDICATED) SLOPE CONTOUR CONCRETE SURFACE EDGE OF ASPHALT EDGE OF BUILDING SIGN POST OR BOLLARD GROUND ELEVATION HARD SURFACE ELEVATION STORM DRAIN LINE STORM DRAIN CLEANOUT DROP INLET AREA DRAIN RAIN WATER LEADER DOWNSPOUT SANITARY SEWER LINE SANITARY SEWER CLEANOUT WATER MANHOLE SANITARY SEWER CLEANOUT WATER MANHOLE SANITARY SEWER CLEANOUT WATER MANHOLE UNDERGROUND ELECTRIC LINE ELECTRIC MATER ELECTRIC MANHOLE UNDERGROUND ELECTRIC LINE UNDERGROUND ELECTRIC LINE UNDERGROUND ELECTRIC LINE UNDERGROUND ELECTRIC LINE ELECTRIC MATER ELECTRIC M |
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TRAFFIC SIGNAL BOX

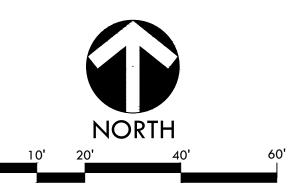


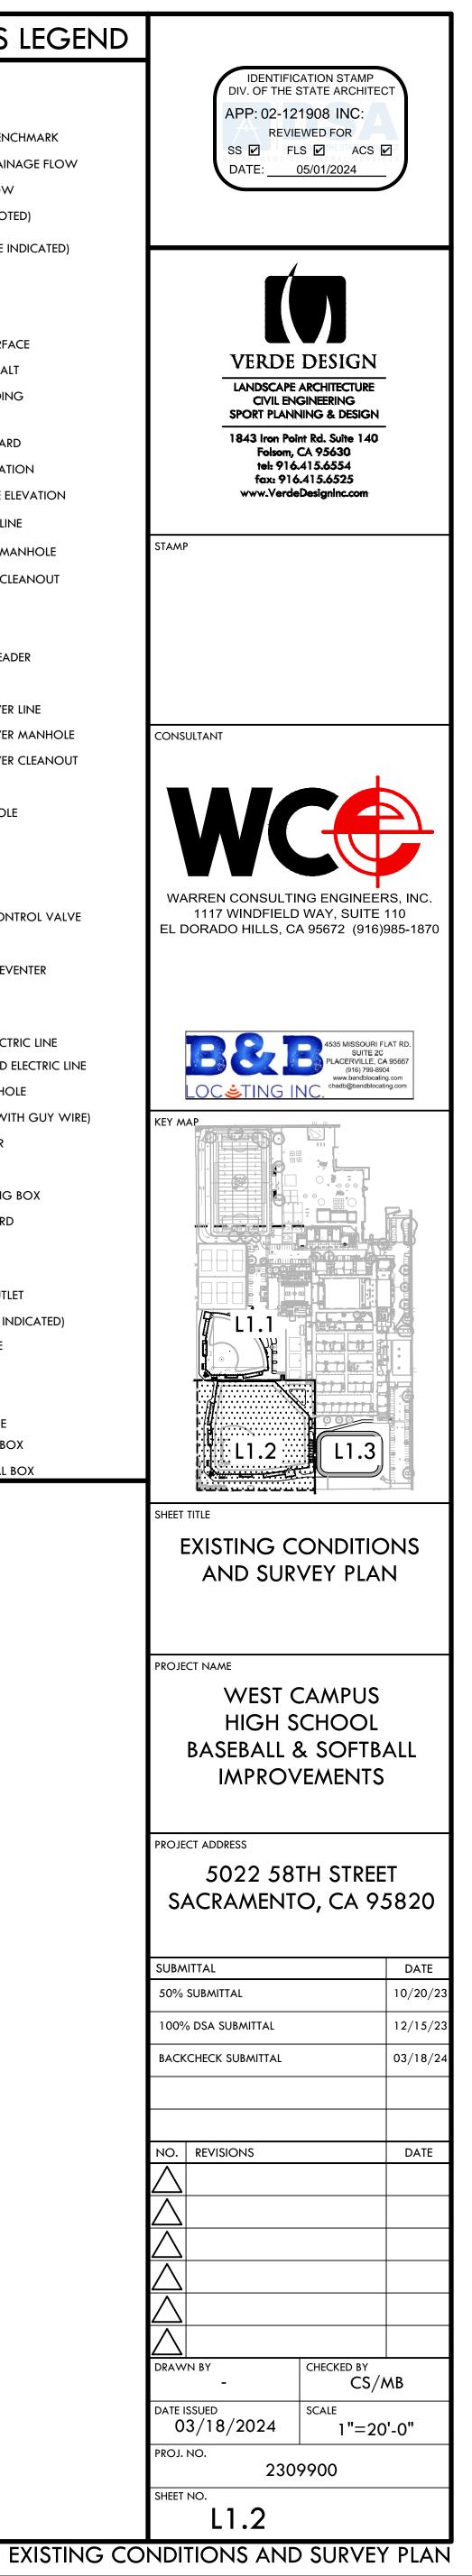


<u>st.</u>

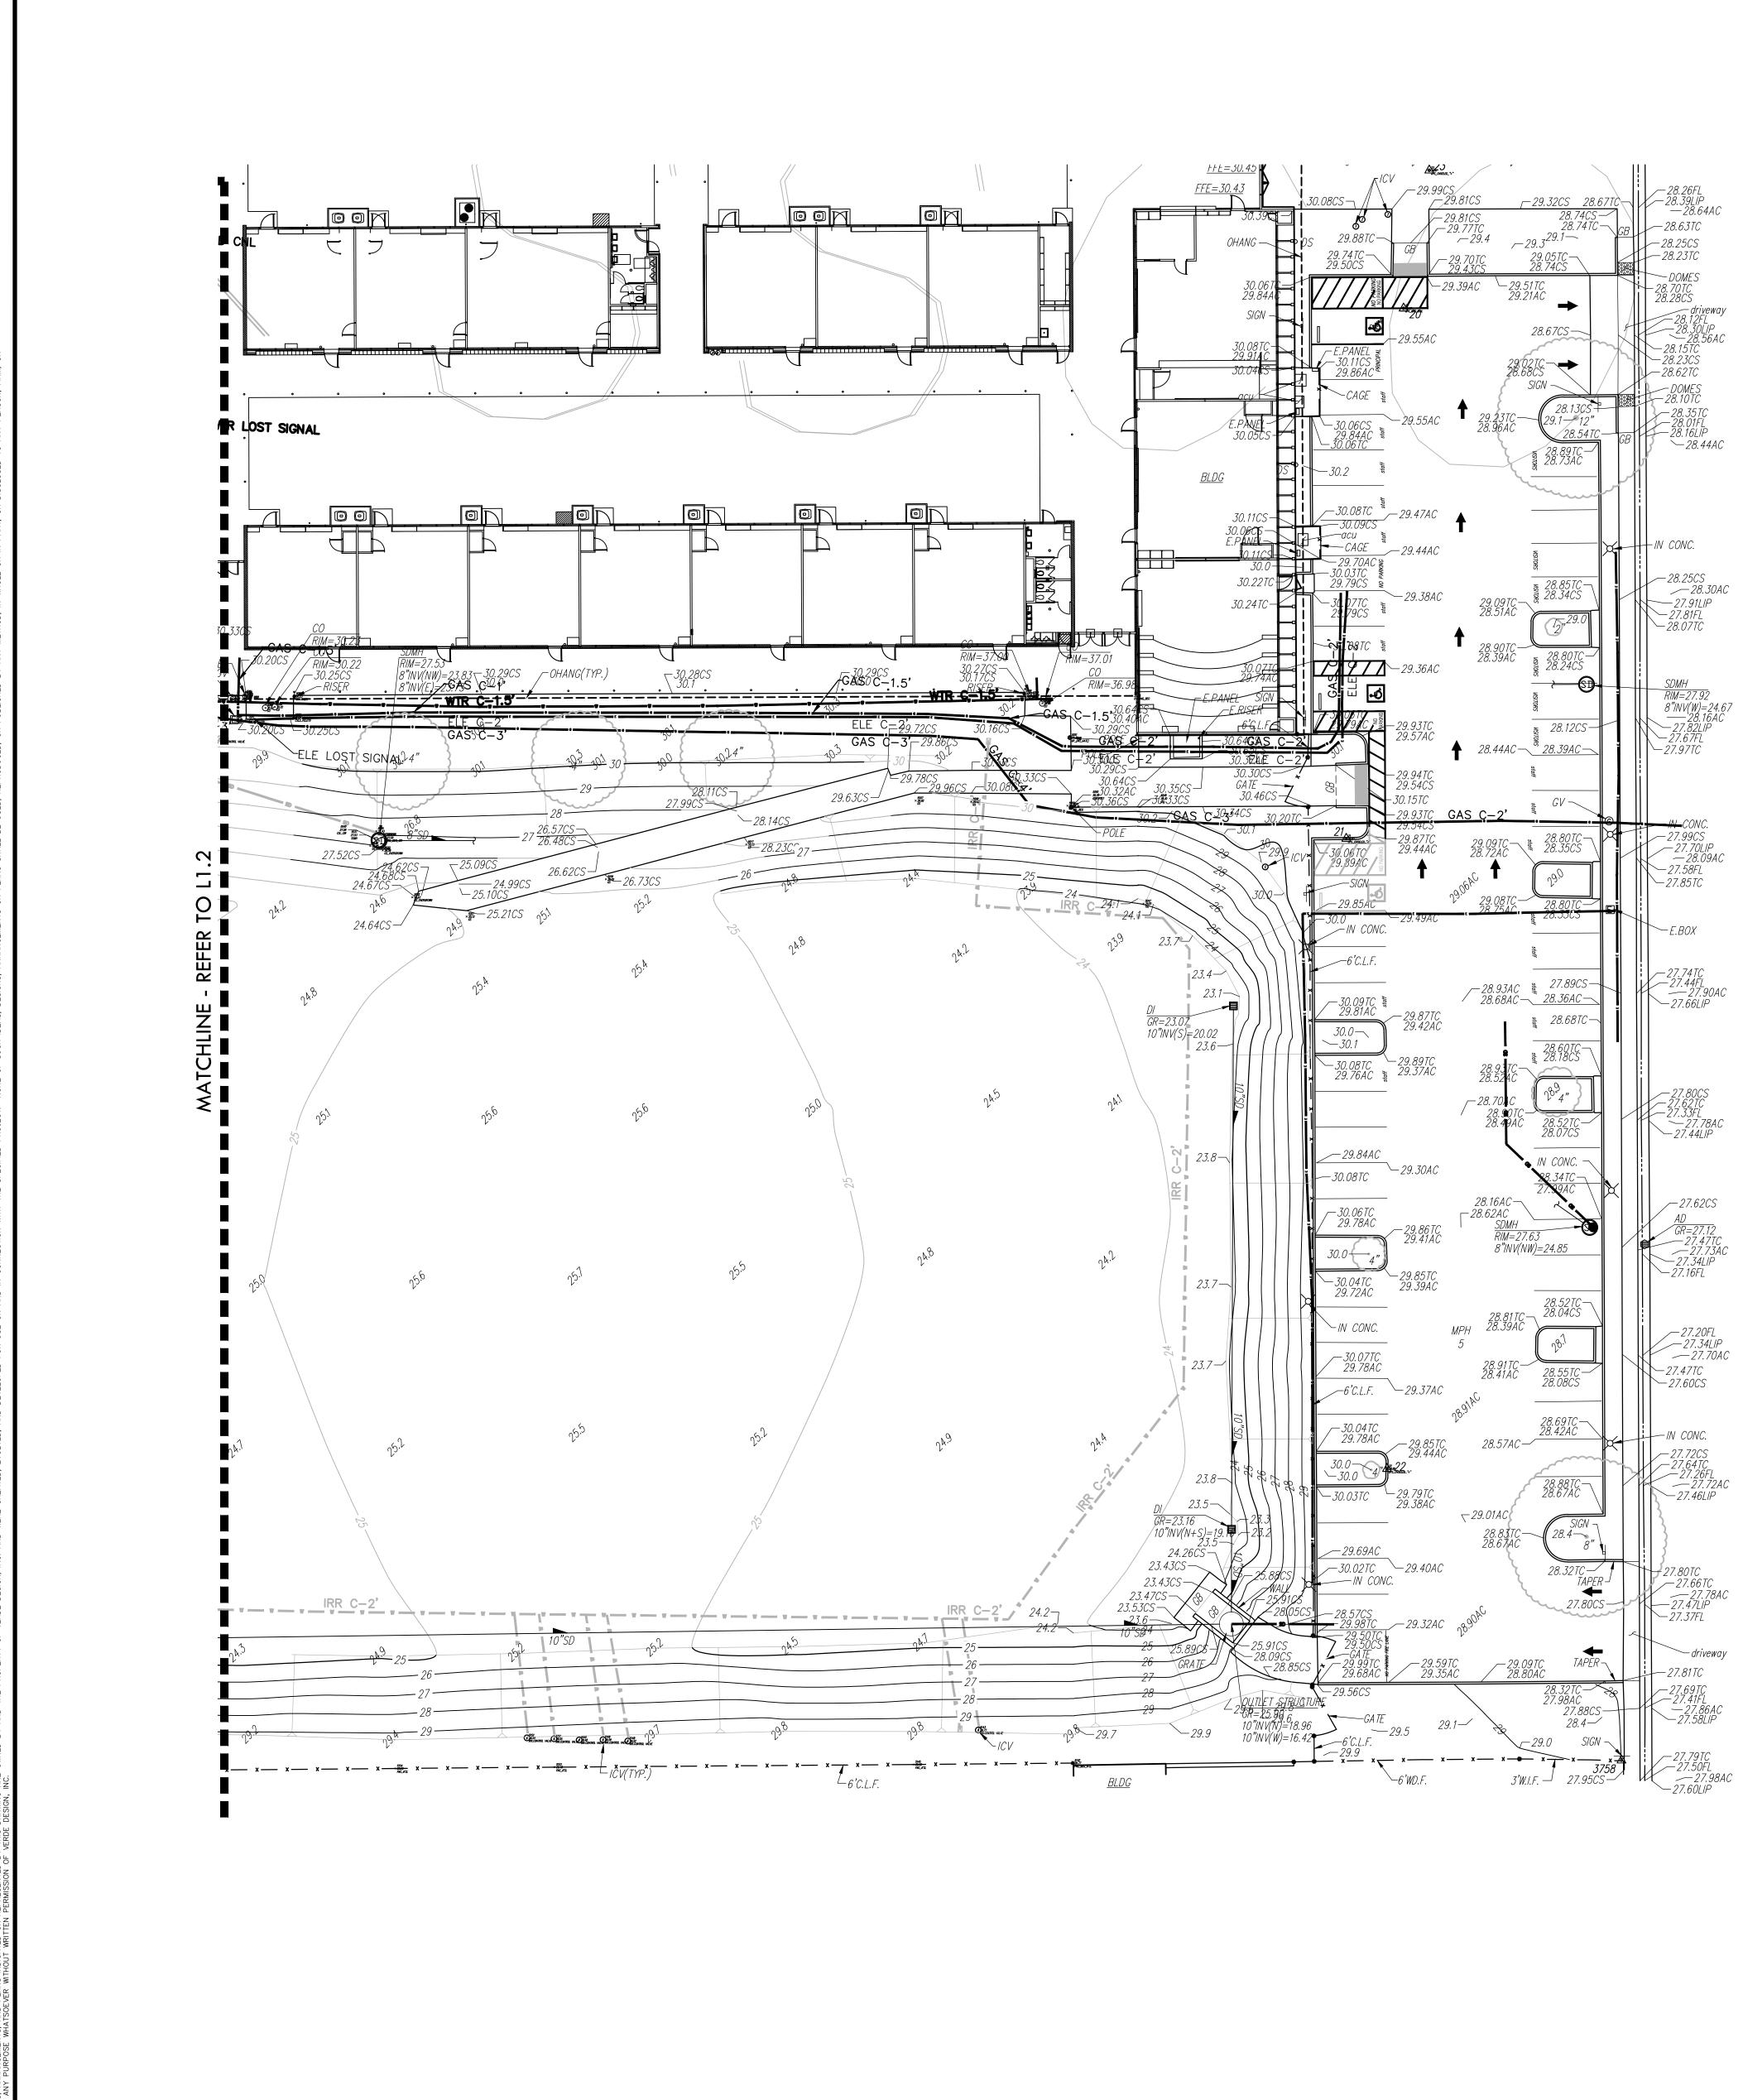
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| | ABBRE | | ٧S | EXISTING CON | DITIONS LEGEN |
|--|---|--|---|--------------|---|
| AC ACU ADN ARALL BCA BCA BCA BCA BCA CATV CATV CATV CATV CATV CATV CATV CA | ASPHALTIC CONCRETE ACCESSIBLE AR CONDITIONING UNIT AREA DRAIN ASSESSOR'S PARCEL NUMBER AIR RELEASE VALVE BASSETBALL POLE BRASS CAP MONUMENT BACK FLOW PREVENTER BLOCK BUIDING BOLLARD BLOW-OFF VALVE BRICK BARBED WIRE FENCE COMMUNICATION CENTERLINE CABLE TELVISION CAPPED IRON PIPE CHAIN UNK FENCE CORRUGATED METAL PIPE CLEANOUT COLUMN CONCRETE CONDENSATE CONTROL POINT FOUND CONTROL POINT SET CONCRETE SURFACE DEPTH DOUBLE DETECTOR CHECK VALVE DRINKING FOUNTAIN DECOMPOSED GRANITE DROW TER DRAWING ELECTRIC EDGE OF PAVEMENT EASEMENT EXISTING FIRE ALARM FIRE DEPARTMENT CONNECTION FINISHED FLOOR ELEVATION FIRE HYDRANT FLOWUNE FIBER OPTIC FIRE SERVICE GAS GRADE BREAK GRATE GROUND ROD BOX GROUND ROD BOX GROUND ROD BOX GROUND ROD BOX GROUND ROD DOX GROUND ROD BOX GROUND ROD MOX GROUND ROD | MH MS MSC NTS OH OIP OSPH P/L PA PB PH PIV PP PRKG PUE PV PVC R RIM ROW RP RWALL RWL SD SDMH SIG SL SLB SS SSCO SSMH STL TBALL TBM TC TOW TP TRW UG VNALL W V/O WD. W.I.F. XF XWALK | MANHOLE MOT TO SCALE OVERHANG OVERHANG OPEN IRON PIPE OLD STEEL POST HOLE PROPERTY LINE PLANTER AREA PARKING BUMPER POST INDICATOR VALVE POST INDICATOR VALVE POST INDICATOR VALVE POST INDICATOR VALVE POST INDICATOR VALVE POST INDICATOR VALVE RUBBER MANHOLE RIM ELEVATION RIGHT OF WAY REDUCED PRESSURE BACKFLOW PREVENTER RETAINING WALL RAIN WATER IEADER STORM DRAIN STORM DRAIN MANHOLE SIGNAL STREET LIGHT BOX SANITARY SEWER CLEANOUT SANITARY SEWER CLEANOUT SANITARY SEWER CLEANOUT SANITARY SEWER MANHOLE STEL TELPHONE TETHER BALL POLE TEMPORARY BENCHMARK TOP OF WALL TELPHONE POLE TOP OF RETAINING WALL UNDERGROUND UNKNOWN VOLLEYBALL WATER WITH WITHOUT WOOD ALL FENCE TRANSFORMER CROSSWALK | | PROPERTY LINE CENTERLINE EASEMENT TEMPORARY BENCHMARK SWALE OR DRAINAGE FLOW DRAINAGE FLOW DRAINAGE FLOW FENCE (TYPE NOTED) TREE (SIZE/TYPE INDICATED) SLOPE CONTOUR CONCRETE SURFACE EDGE OF BUILDING SIGN POST OR BOLLARD GROUND ELEVATION ARD SURFACE ELEVATION STORM DRAIN LINE STORM DRAIN CLEANOUT DROP INLET AREA DRAIN RAIN WATER LEADER DOWNSPOUT SANITARY SEWER LINE SANITARY SEWER LINE SANITARY SEWER LINE SANITARY SEWER LINE SANITARY SEWER CLEANOUT WATER MANHOLE UTILITY POLE (WITH GUY WIRE) ELECTRIC MANHOLE UTILITY POLE (WITH GUY WIRE) ELECTRIC MATER SIGNAL LIGHT FLOOD LIGHT LIGHT STANDARD SIGNAL LIGHT LIGHT STANDARD GAS MANHOLE SIGNAL LIGHT LIGHT STANDARD GAS MANHOLE GAS MANHOLE MATER COULIGHT COULIGHT COULIGHT< |

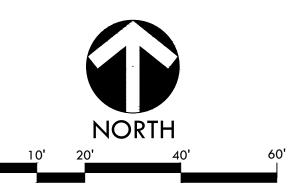


TRAFFIC SIGNAL BOX



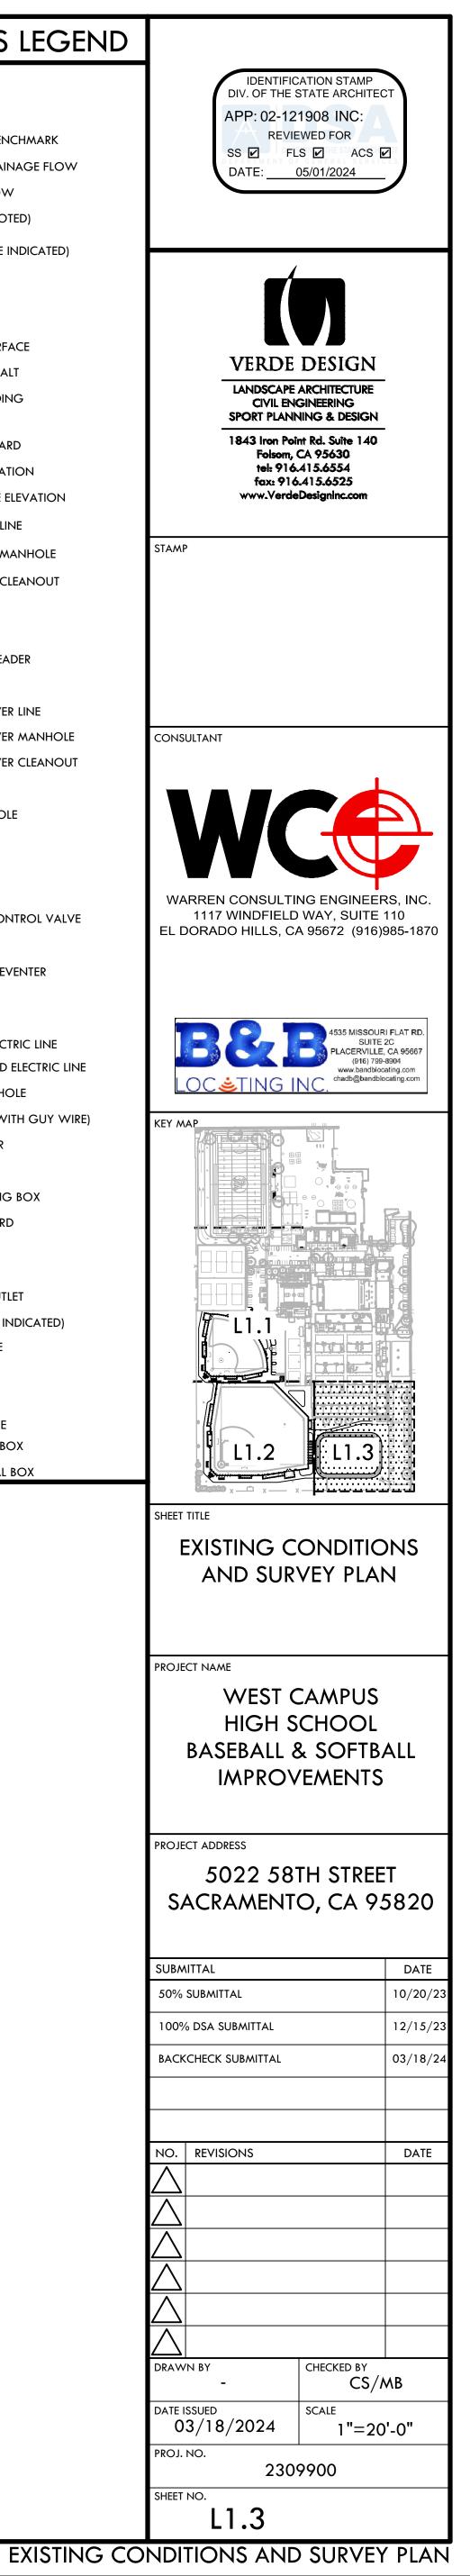


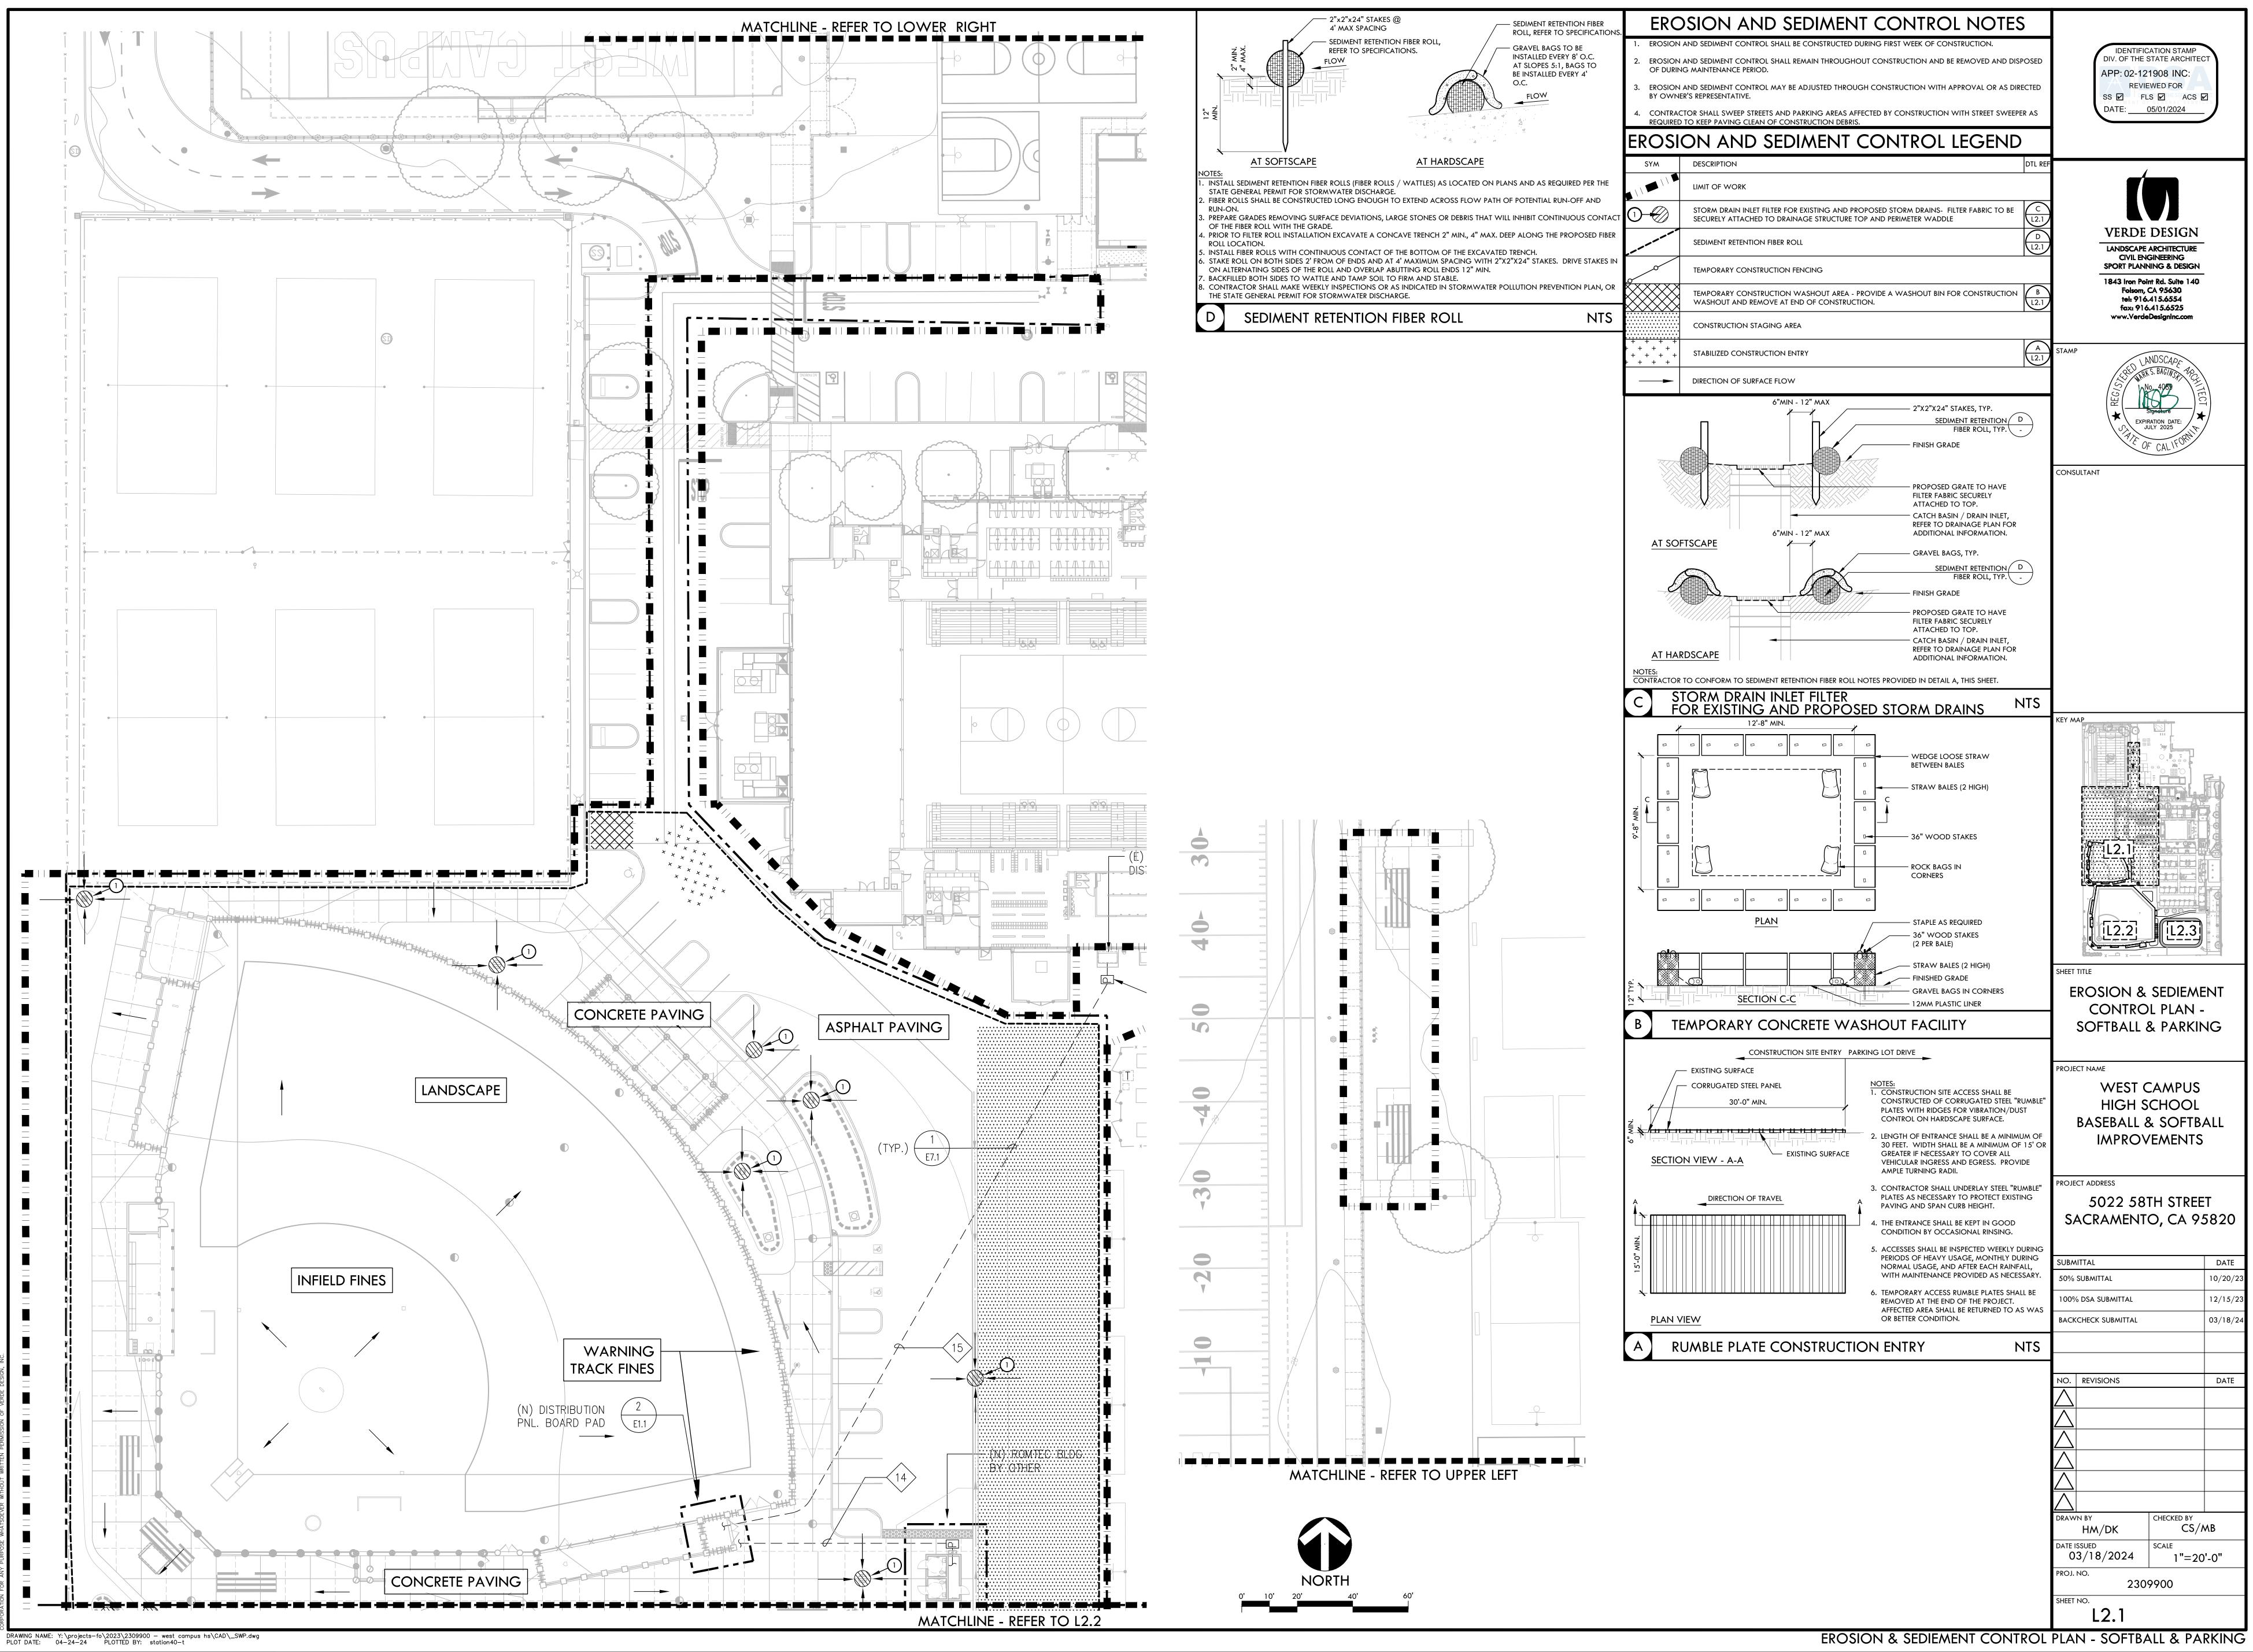


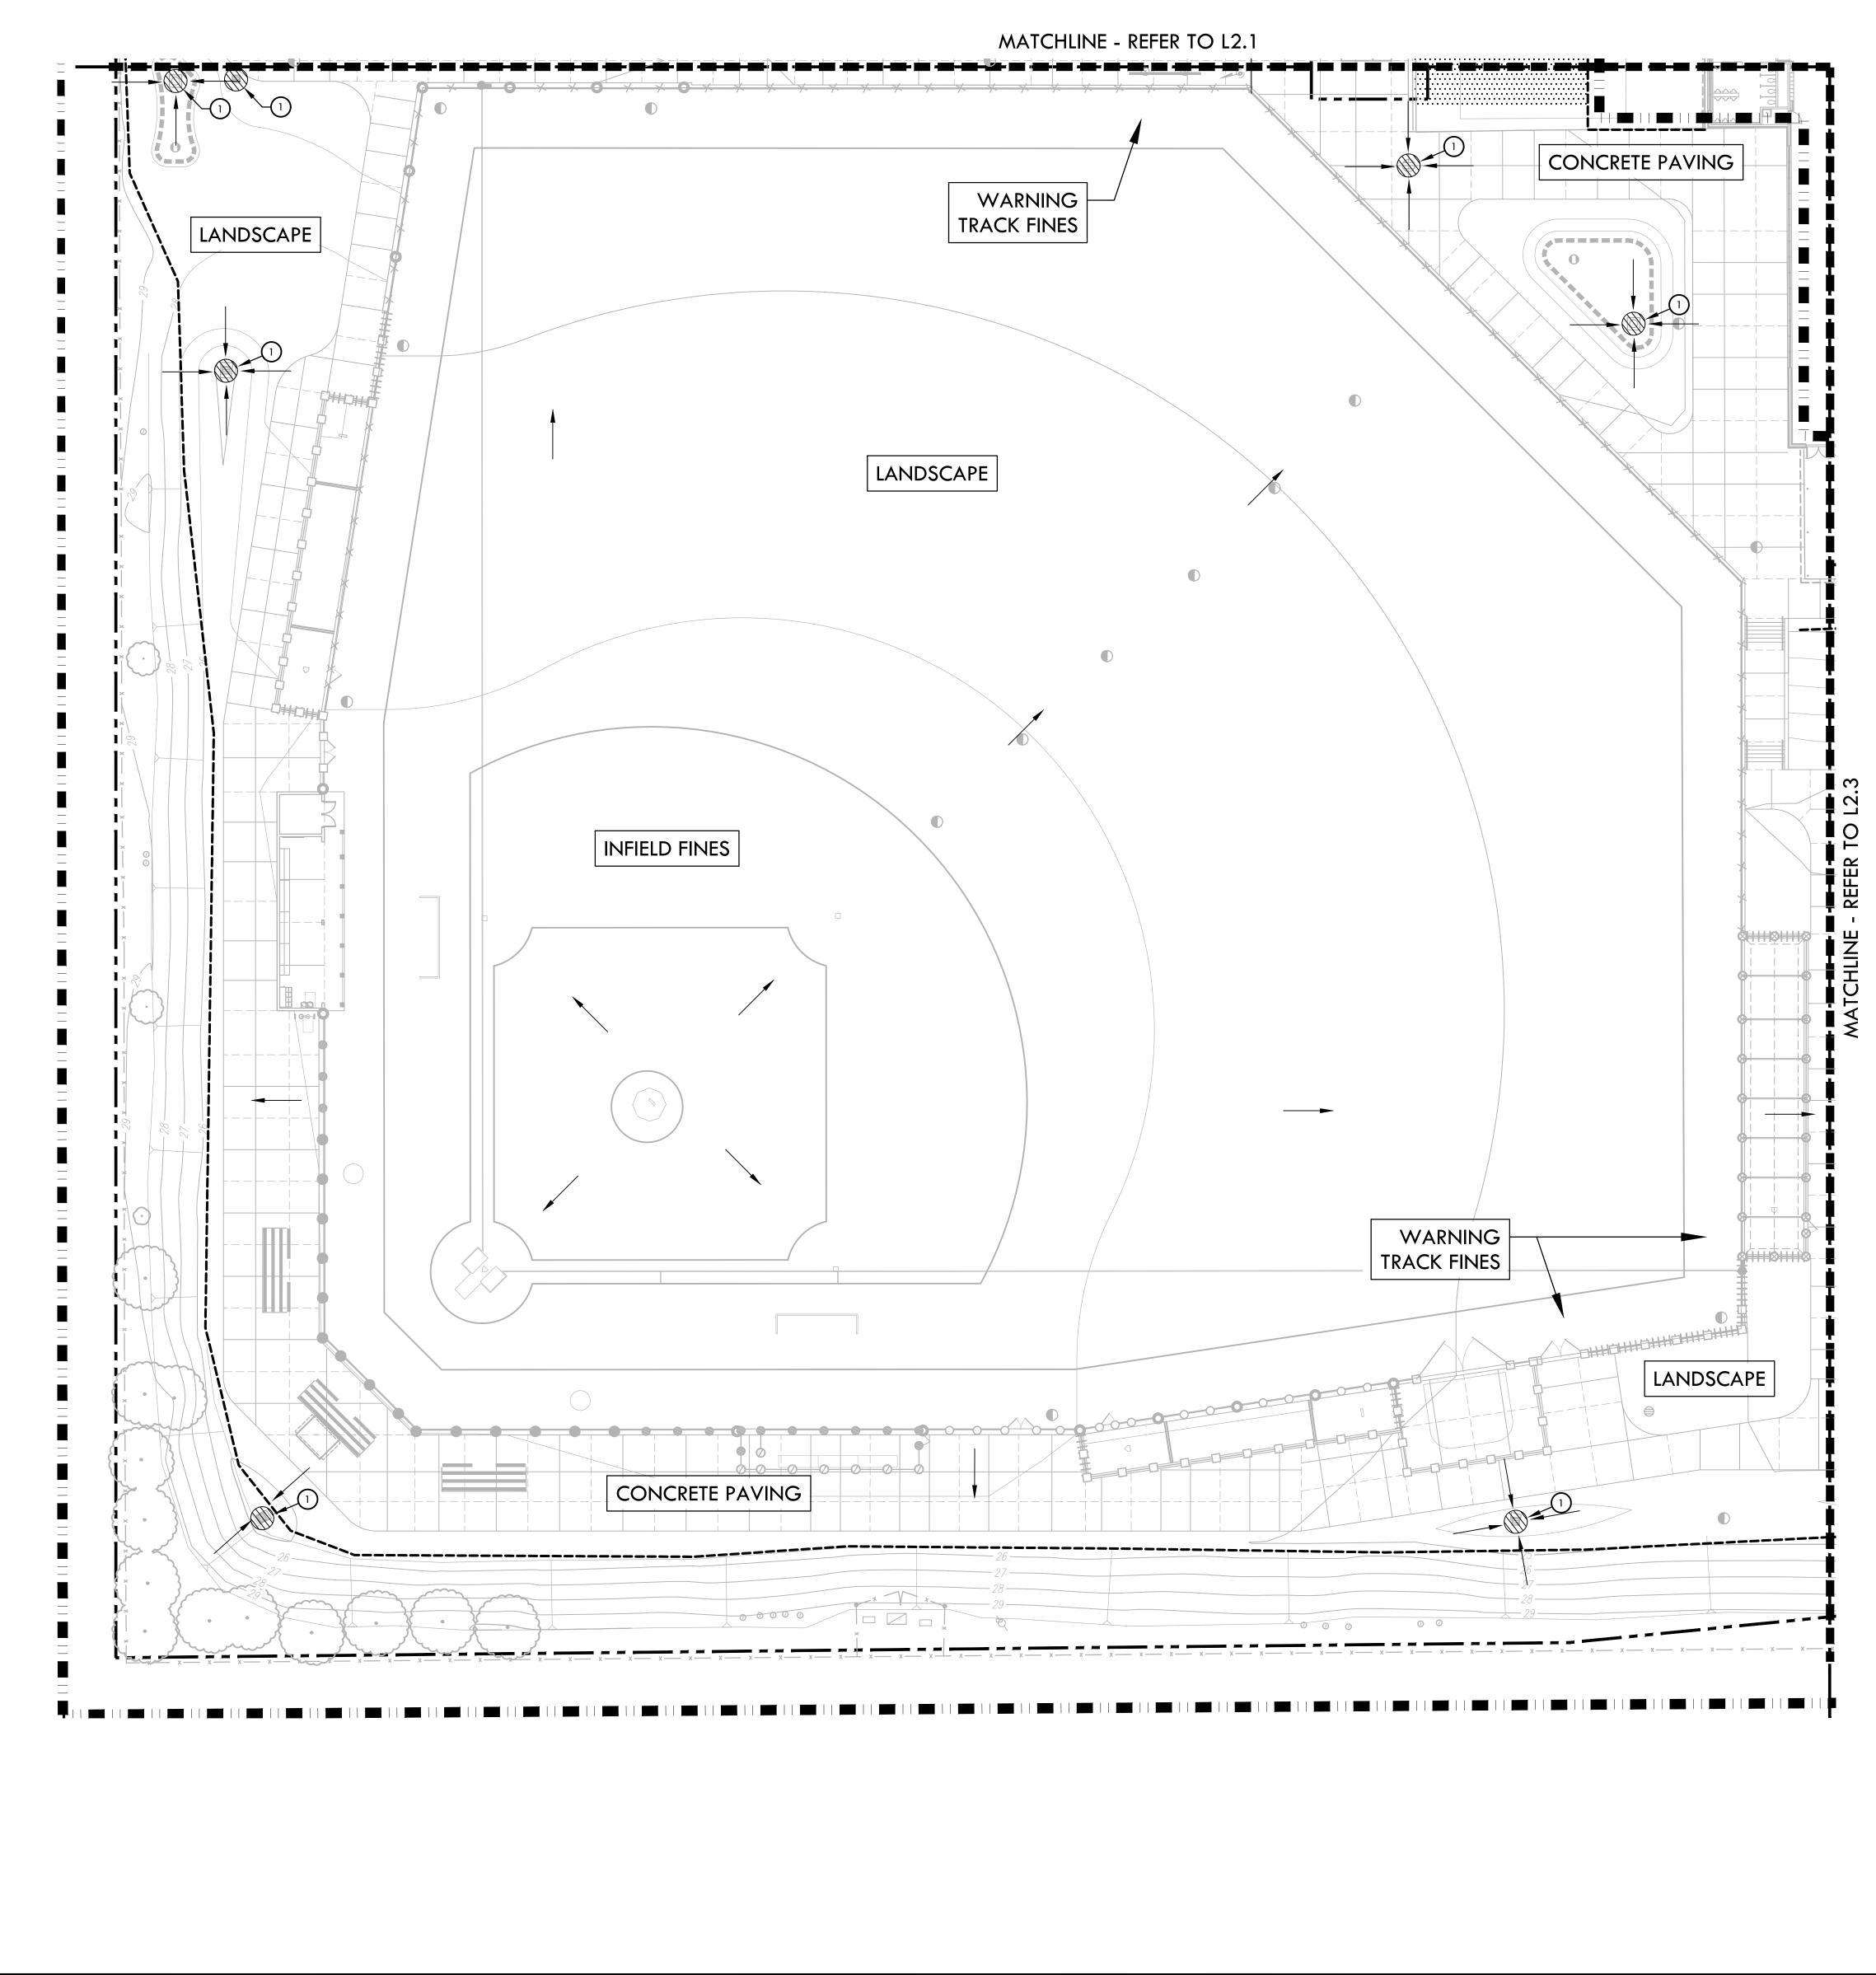


DRAWING NAME: Y:\projects-fo\2023\2309900 - west campus hs\CAD_SWP.dwg PLOT DATE: 04-24-24 PLOTTED BY: station40-t

| ERC | DSION AND SEDIMENT CONTROL NOTES | 5 |
|---------------------------------------|---|---------|
| 1. EROSION | I AND SEDIMENT CONTROL SHALL BE CONSTRUCTED DURING FIRST WEEK OF CONSTRUCTION. | |
| | I AND SEDIMENT CONTROL SHALL REMAIN THROUGHOUT CONSTRUCTION AND BE REMOVED AND DIS NG MAINTENANCE PERIOD. | PC |
| | I AND SEDIMENT CONTROL MAY BE ADJUSTED THROUGH CONSTRUCTION WITH APPROVAL OR AS DIR ER'S REPRESENTATIVE. | ?EC |
| | CTOR SHALL SWEEP STREETS AND PARKING AREAS AFFECTED BY CONSTRUCTION WITH STREET SWEEP D TO KEEP PAVING CLEAN OF CONSTRUCTION DEBRIS. | ER |
| EROSI | ON AND SEDIMENT CONTROL LEGEND |) |
| SYM | DESCRIPTION | 0 |
| | LIMIT OF WORK | |
| 0-0 | STORM DRAIN INLET FILTER FOR EXISTING AND PROPOSED STORM DRAINS- FILTER FABRIC TO BE SECURELY ATTACHED TO DRAINAGE STRUCTURE TOP AND PERIMETER WADDLE | K |
| | SEDIMENT RETENTION FIBER ROLL | ł |
| 00 | TEMPORARY CONSTRUCTION FENCING | |
| | TEMPORARY CONSTRUCTION WASHOUT AREA - PROVIDE A WASHOUT BIN FOR CONSTRUCTION WASHOUT AND REMOVE AT END OF CONSTRUCTION. | ł |
| | CONSTRUCTION STAGING AREA | |
| + + + + + + + + + + + + + + + + + + + | STABILIZED CONSTRUCTION ENTRY | (|
| | DIRECTION OF SURFACE FLOW | |

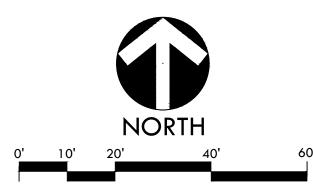

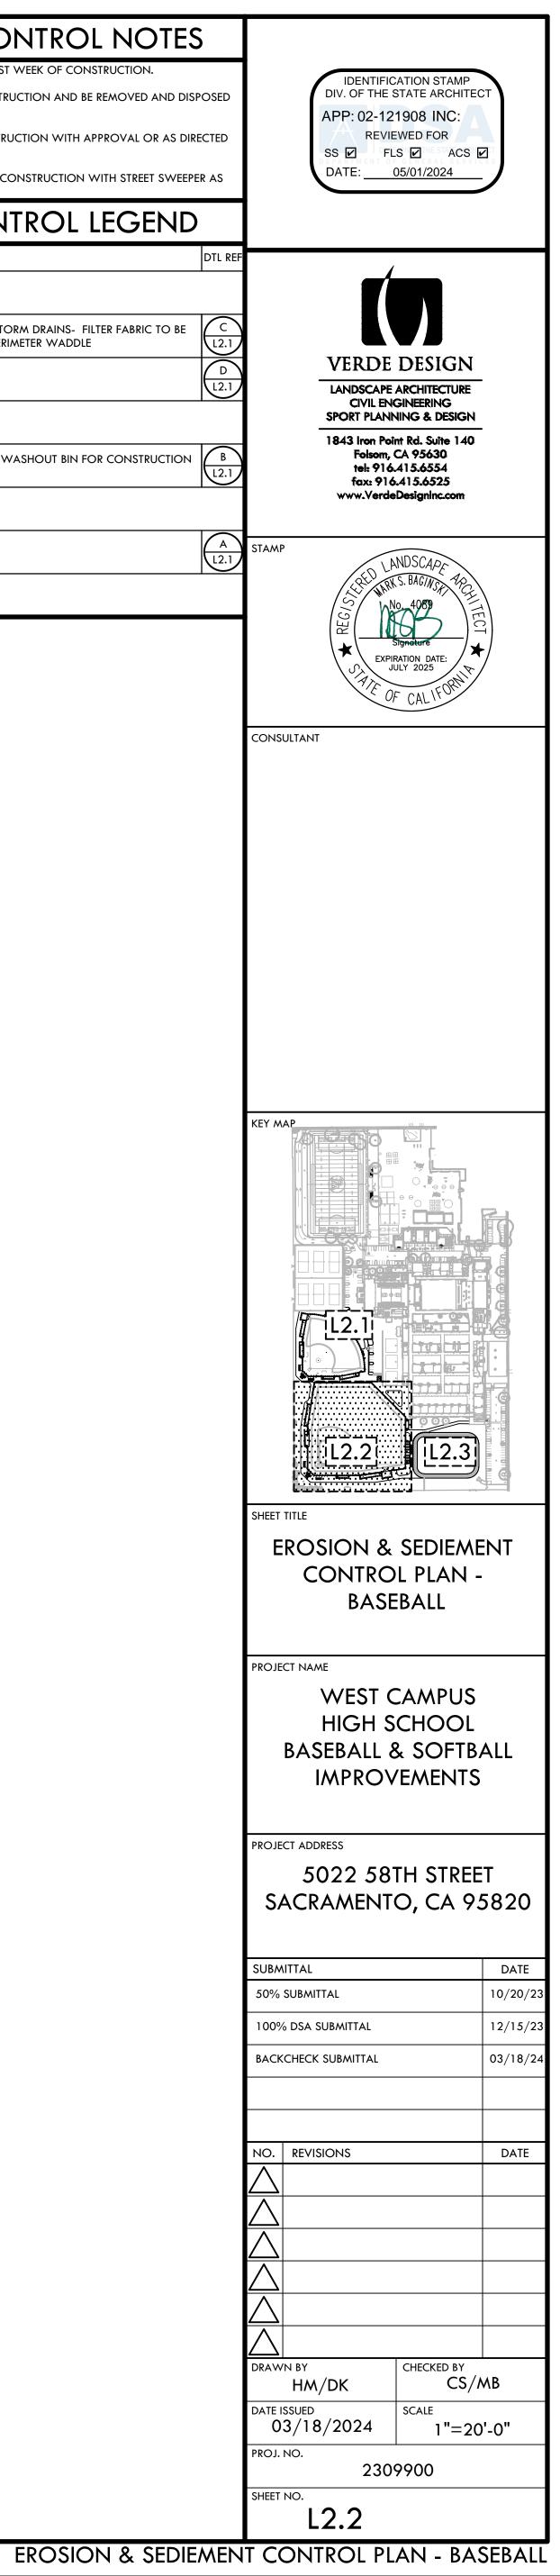





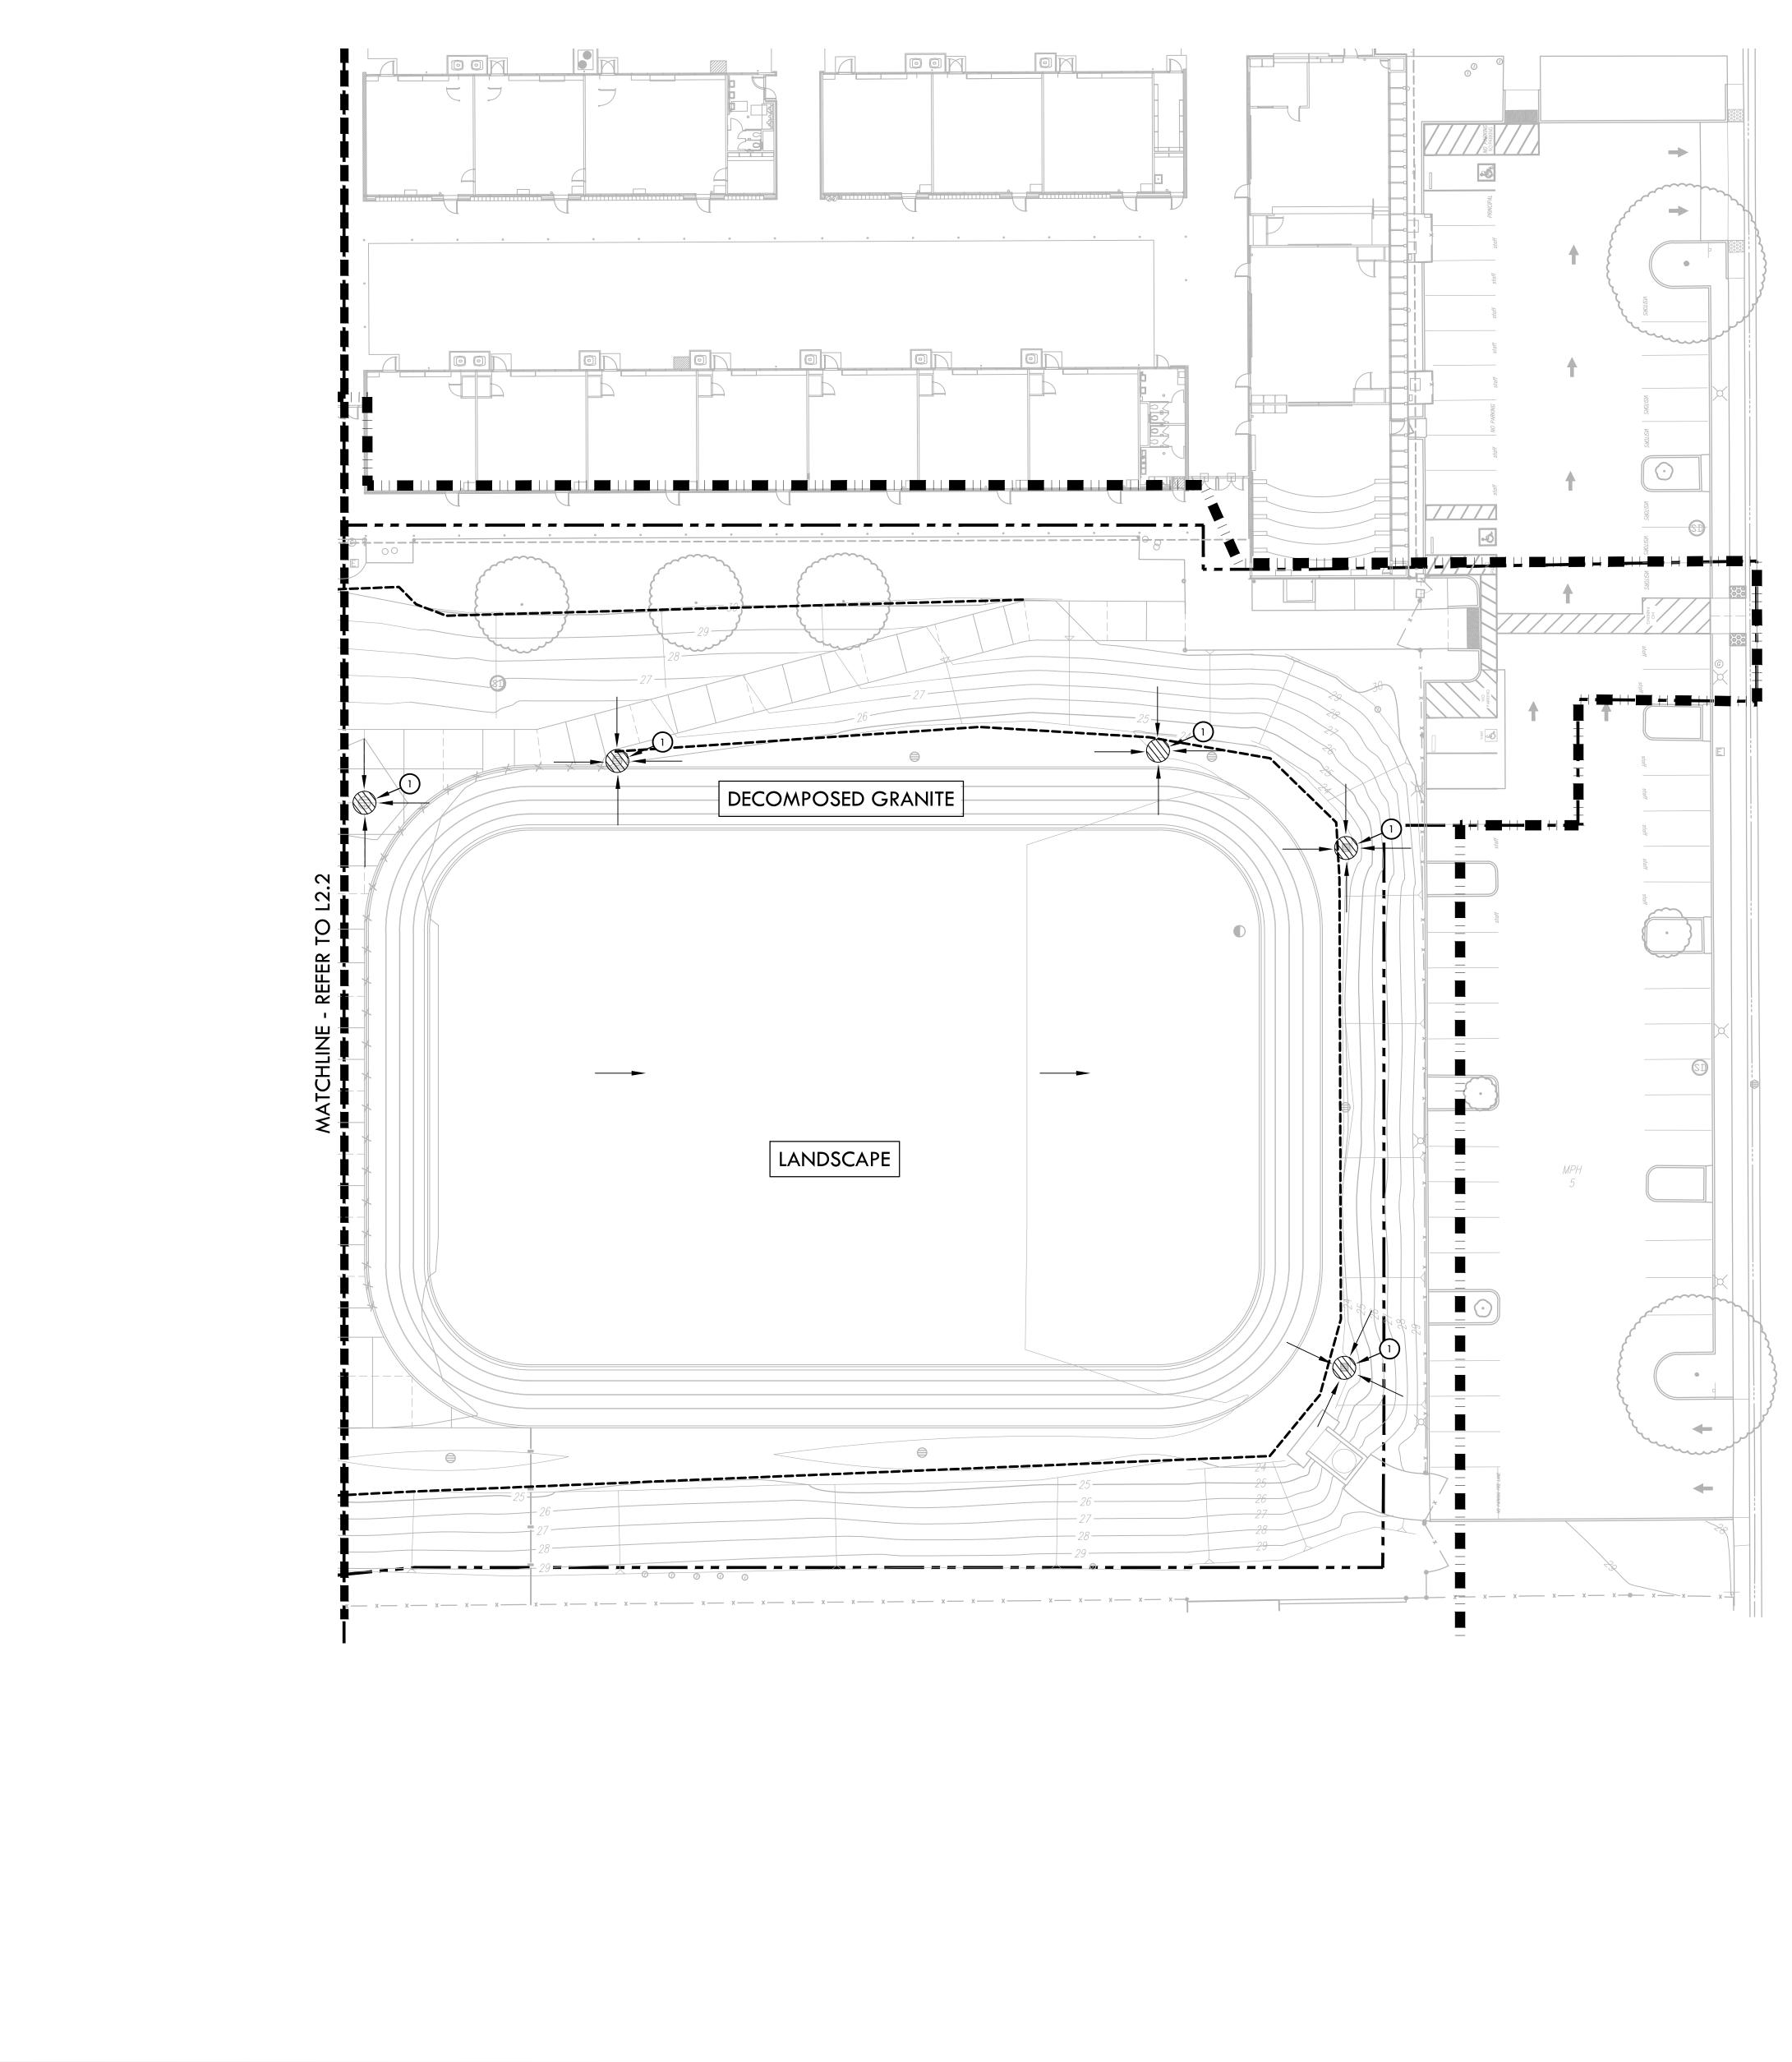


DRAWING NAME: Y:\projects-fo\2023\2309900 - west campus hs\CAD_SWP.dwg PLOT DATE: 04-24-24 PLOTTED BY: station40-t

| ERC | DSION AND SEDIMENT CONTROL NOTES | 3 |
|---------------------------------------|---|----|
| 1. EROSION | AND SEDIMENT CONTROL SHALL BE CONSTRUCTED DURING FIRST WEEK OF CONSTRUCTION. | |
| | I AND SEDIMENT CONTROL SHALL REMAIN THROUGHOUT CONSTRUCTION AND BE REMOVED AND DIS NG MAINTENANCE PERIOD. | PC |
| | I AND SEDIMENT CONTROL MAY BE ADJUSTED THROUGH CONSTRUCTION WITH APPROVAL OR AS DIR ER'S REPRESENTATIVE. | EC |
| | CTOR SHALL SWEEP STREETS AND PARKING AREAS AFFECTED BY CONSTRUCTION WITH STREET SWEEP TO KEEP PAVING CLEAN OF CONSTRUCTION DEBRIS. | ER |
| EROSI | ON AND SEDIMENT CONTROL LEGEND |) |
| SYM | DESCRIPTION | ۵ |
| | LIMIT OF WORK | |
| 0- | STORM DRAIN INLET FILTER FOR EXISTING AND PROPOSED STORM DRAINS- FILTER FABRIC TO BE SECURELY ATTACHED TO DRAINAGE STRUCTURE TOP AND PERIMETER WADDLE | K |
| | SEDIMENT RETENTION FIBER ROLL | K |
| 00 | TEMPORARY CONSTRUCTION FENCING | |
| | TEMPORARY CONSTRUCTION WASHOUT AREA - PROVIDE A WASHOUT BIN FOR CONSTRUCTION WASHOUT AND REMOVE AT END OF CONSTRUCTION. | (|
| | CONSTRUCTION STAGING AREA | |
| + + + + + + + + + + + + + + + + + + + | STABILIZED CONSTRUCTION ENTRY | (|
| | DIRECTION OF SURFACE FLOW | |

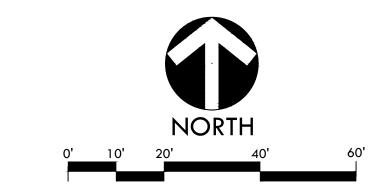

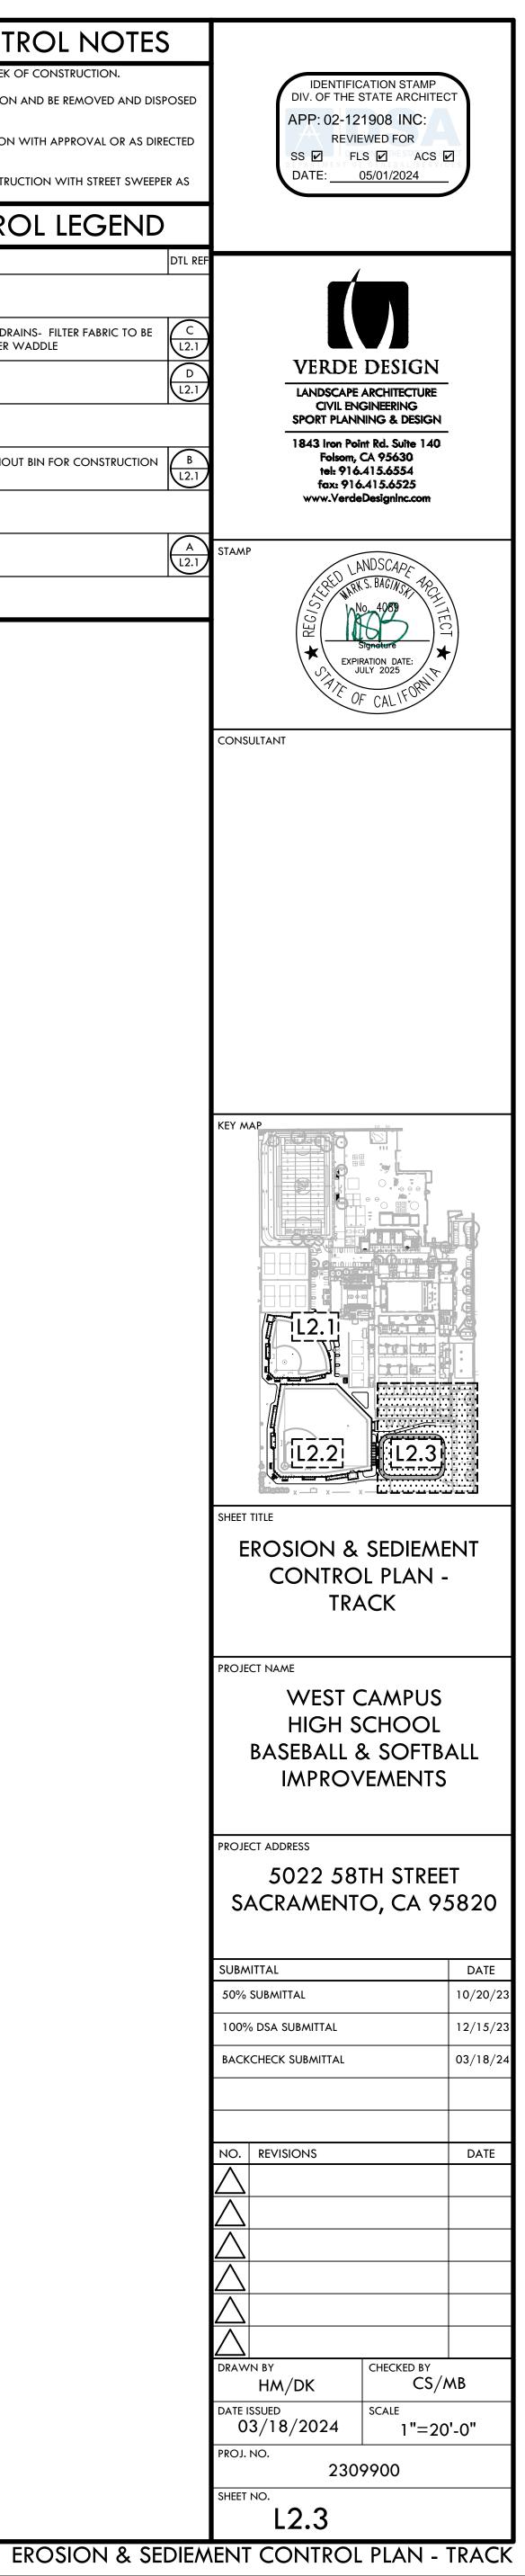


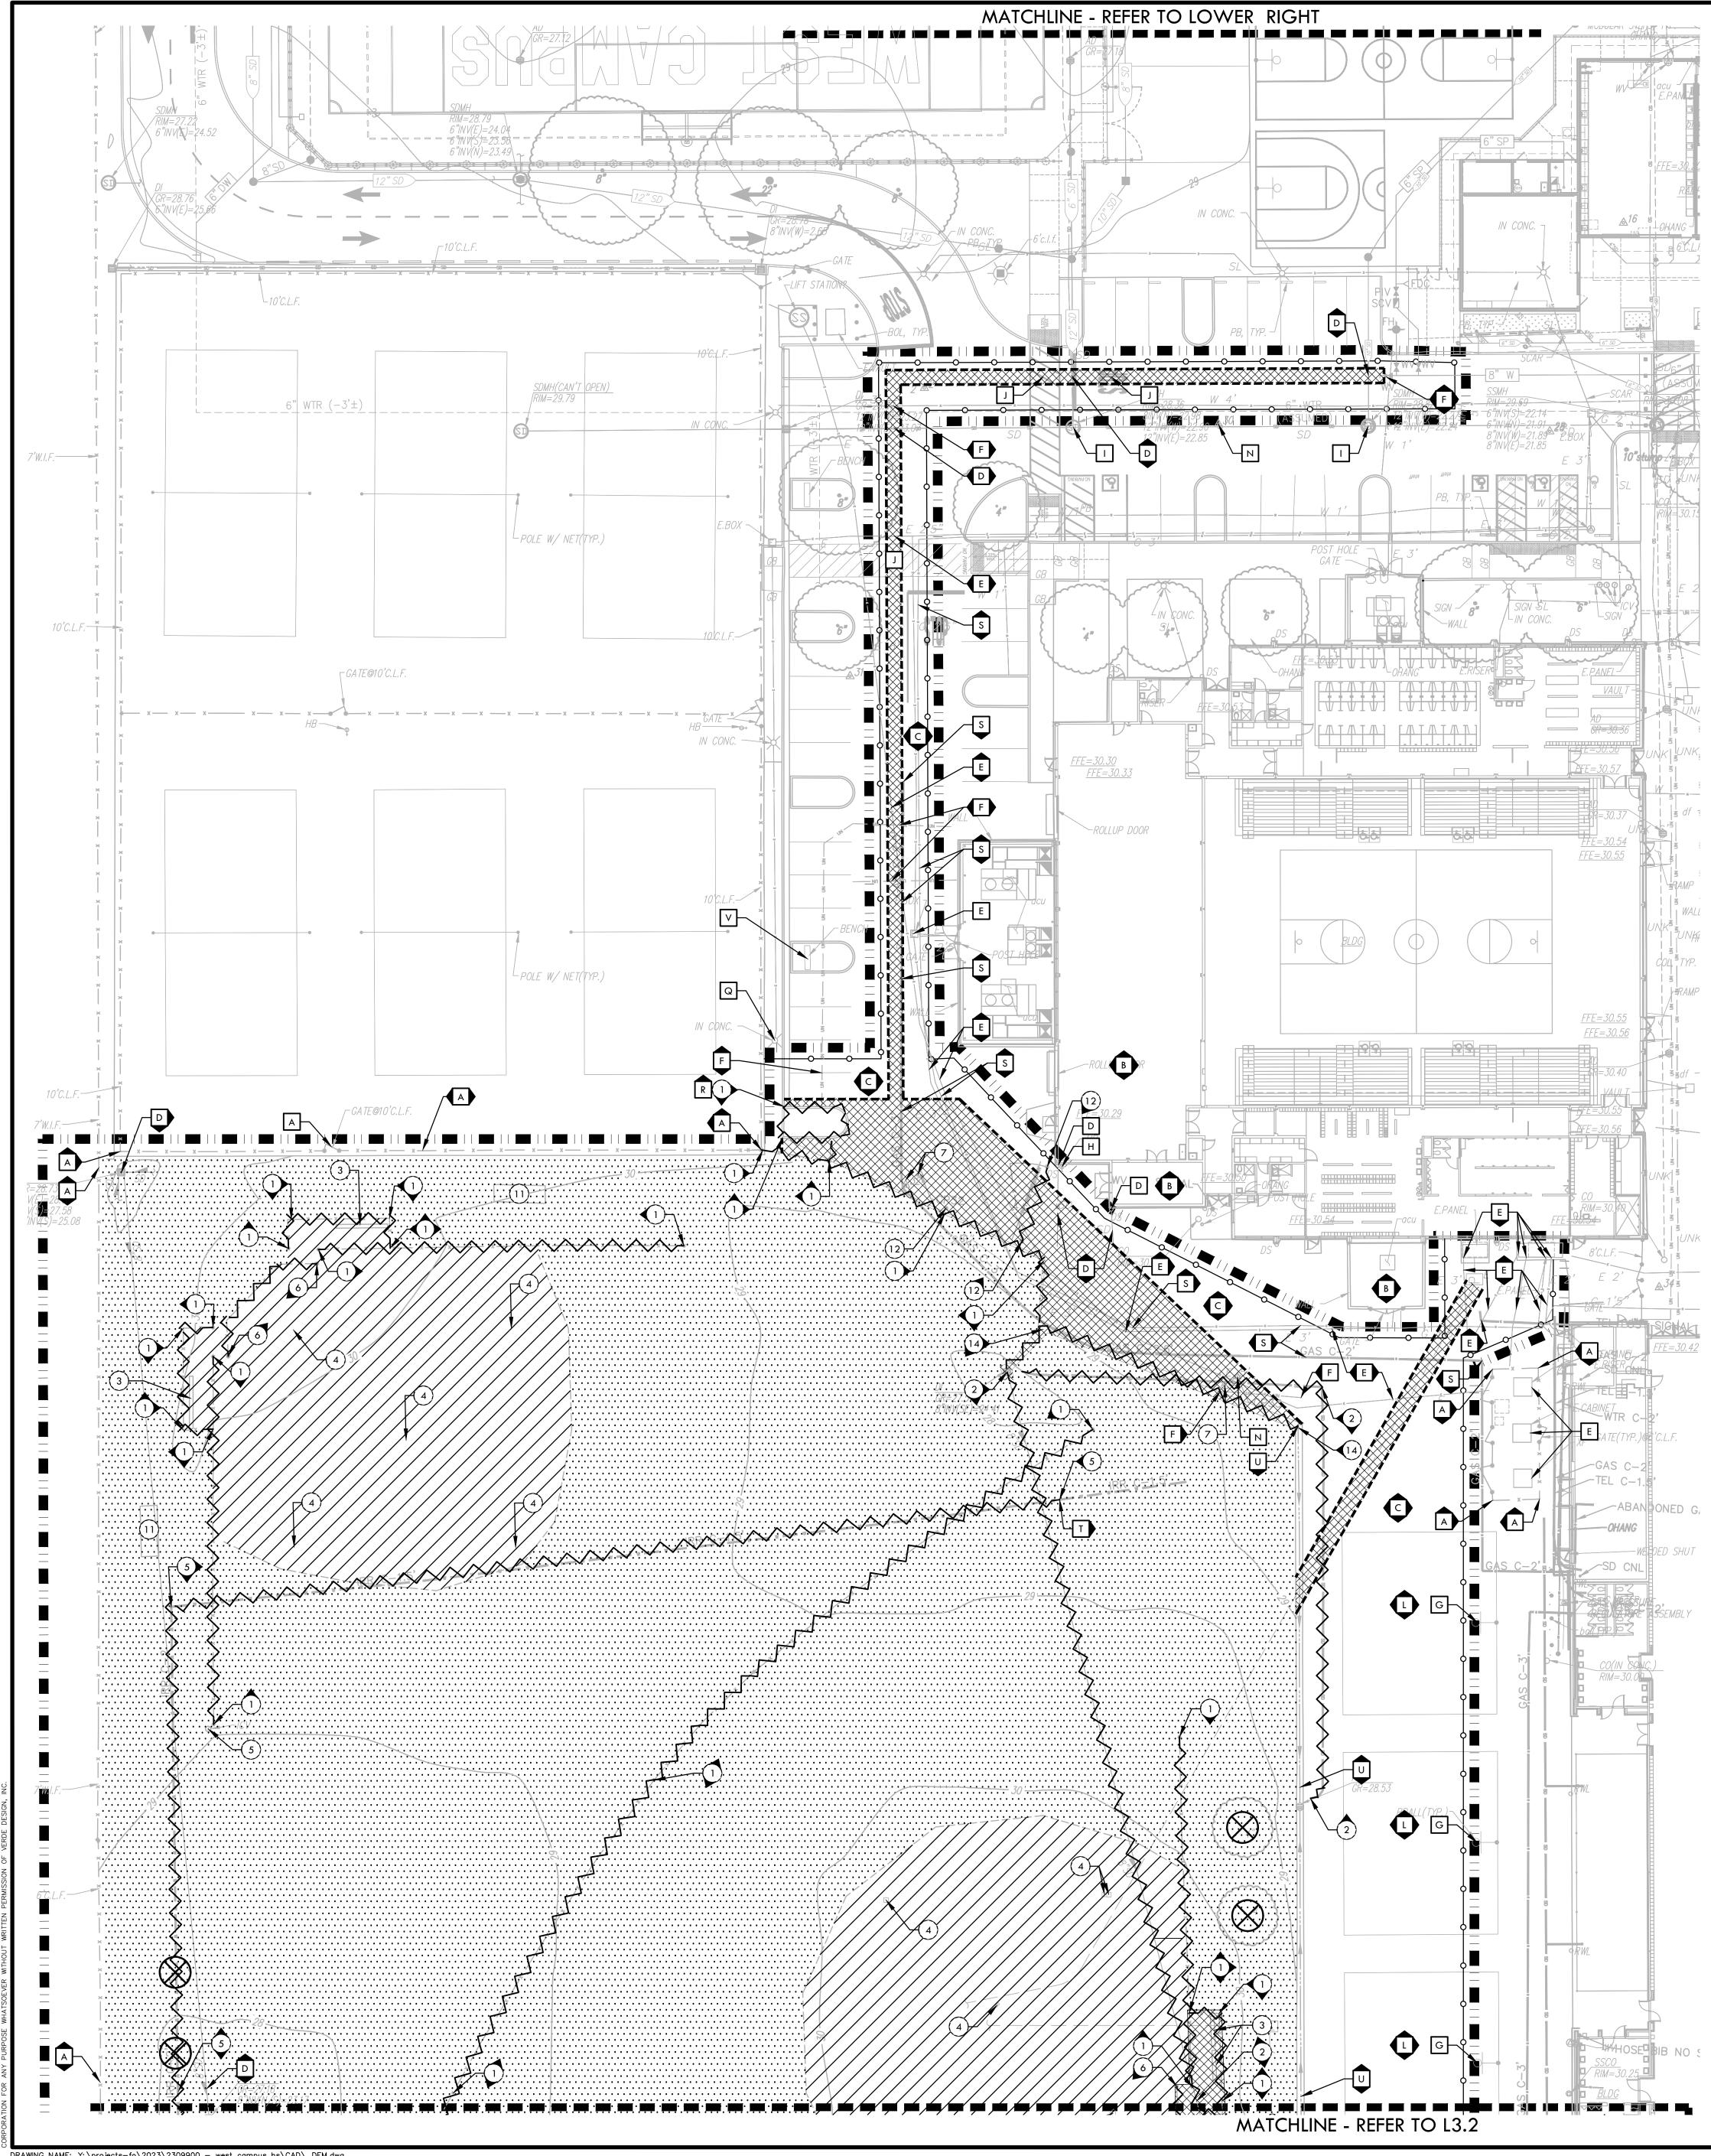


DRAWING NAME: Y:\projects-fo\2023\2309900 - west campus hs\CAD_DEM.dwg PLOT DATE: 04-24-24 PLOTTED BY: station40-t

| ITEMS TO BE DEMOLISHED | 4 | | DEMOLITION NOTES |
|--|--------|--------------------------|---|
| CONCRETE SWALE TO BE DEMOLISHED AND REMOVED. | 1. | OBSTRUCTI | RACTOR SHALL PERFORM ALL CLEARING, DEMOLITION, REMOVAL OF ONS & SITE PREPARATIONS NECESSARY FOR THE PROPER EXECUTION OF ALL NTAINED IN THE CONTRACT DOCUMENTS. |
| 2 EXISTING DRAIN STRUCTURE TO BE DEMOLISHED AND REMOVED. ALL DRAIN LINES TO BE ABANDONED IF NOT OBSTRUCTING FUTURE IMPROVEMENTS. DRAIN LINES OBSTRUCTING FUTURE IMPROVEMENTS TO BE DEMOLISHED AND REMOVED. | 2. | CONTRACT | TOR SHALL VERIFY LOCATION OF ALL EXISTING UTILITIES & PROVIDE THE REQU TION FOR THEIR TEMPORARY DISCONNECTION, PROTECTION, REMOVAL AND |
| 3 EXISTING FURNISHINGS TO BE DEMOLISHED AND REMOVED. | | STORAGE A | AS MAY BE REQUIRED DURING CONSTRUCTION. CONTRACTOR SHALL ATE WITH THE DISTRICT TO DETERMINE WHETHER TEMPORARY SERVICES ARE |
| EXISTING BASES TO BE TURNED OVER TO DISTRICT. SLEEVES, MOUND AND HOME PLATE TO BE DEMOLISHED AND REMOVED. | 3. | | RACTOR SHALL VISIT THE SITE TO DETERMINE THE EXACT EXTENT & DEPTH OF S |
| 5 EXISTING IRRIGATION MAINLINE, VALVES, LATERALS, AND HEADS TO BE DEMOLISHED AND REMOVED OR ABANDONED (WHEN NOT IN CONFLICT WITH NEW WORK). | | NOTIFIED I | IN REQUIRED & VERIFY COMPLIANCE WITH DRAWINGS. THE DISTRICT SHALL I MMEDIATELY OF ANY DISCREPANCIES. |
| EXISTING BACKSTOP TO BE DEMOLISHED AND REMOVED. CONTRACTOR TO REMOVE FOOTINGS. | 4. | CONSTRUC EXISTING U | OR SHALL COMPLETE POT-HOLING & UTILITY LOCATIONS PRIOR TO TION COMMENCING. THE CONTRACTOR SHALL VERIFY THE LOCATIONS OF ITILITIES, STRUCTURES & SERVICES BEFORE COMMENCING WORK. THE |
| 5 SURVEY MARKER TO BE DEMOLISHED AND REMOVED. | | SHALL BE D SHOWN & | S OF UTILITIES, STRUCTURES & SERVICES SHOWN IN THE CONTRACT DOCUME EEMED TO BE APPROXIMATIONS ONLY. ALL DISCREPANCIES BETWEEN WHAT THE ACTUAL FIELD CONDITIONS SHALL BE REPORTED TO THE DISTRICT'S |
| (8) EXISTING UTILITY BOXES TO BE DEMOLISHED AND REMOVED. (9) EXISTING PORTABLE BUILDING TO BE DEMOLISHED AND REMOVED. ELECTRICAL | | AT (800) 22 USA MARKI | ATIVE. THE CONTRACTOR SHALL CONTACT UNDERGROUND SERVICE ALERT (L 27-2600 PRIOR TO ANY DEMOLITION OR EXCAVATION. UPON COMPLETION ING OPERATIONS, CONTRACTOR SHALL RECORD ALL UTILITY MARKINGS ON A |
| POWER TO BE STUBBED. REFER TO ELECTRICAL PLANS. (10) STORAGE CONTAINER TO BE RELOCATED. REFER TO DISTRICT FOR LOCATION. | | DURATION | SET OF DRAWINGS. THIS SET SHALL BE KEPT ON-SITE FOR REFERENCE FOR OF CONTRACT. NOTIFY THE DISTRICT'S REPRESENTATIVE IMMEDIATELY SHOU 5 ARISE & REDIRECT WORK TO AVOID DELAY. |
| 1) BLEACHER TO BE DEMOLISHED AND REMOVED. | 5. | | IG ITEMS ARE TO REMAIN UNLESS OTHERWISE NOTED. THE CONTRACTOR SH SIBLE FOR REPAIRING OR REPLACING, AT CONTRACTOR'S EXPENSE, ANY EXIS |
| 2 METAL POSTS AND FOOTINGS, AND METAL SWING GATE, TO BE DEMOLISHED AND REMOVED. | | ALSO BE RE | GED OR DESTROYED BY CONSTRUCTION OPERATIONS. CONTRACTOR SHAL ESPONSIBLE FOR REPAIRING OR REPLACING ANY & ALL DAMAGES TO ADJAC 5. THE DAMAGED ITEMS SHALL BE RESTORED TO AN "AS-WAS" OR BETTER |
| 13 SIGN, POST AND FOOTING SHALL BE DEMOLISHED AND REMOVED. | 6. | | N OR REPLACED PER THE DISCRETION OF THE DISTRICT'S REPRESENTATIVE. |
| (14) CONCRETE SWALE TO BE DEMOLISHED AND REMOVED. | | INTERLOCK | ING CHAIN-LINK TEMPORARY CONSTRUCTION FENCING TO ENCLOSE & SEC CT AREA LIMIT OF WORK. THE FENCING SHALL CONTAIN PEDESTRIAN AND/C ACCESS GATES AS NECESSARY & SHALL BE MINIMUM 6 FEET HIGH WITH A T |
| | | & BOTTOM SHALL INCL | A RAIL WITH KNUCKLED TOP & BOTTOM SELVAGE (NO BARBED WIRE PERMITTI UDE FULL HEIGHT GREEN SHADE CLOTH COVERING. THE CONSTRUCTION VORK SHALL BE SUBJECT TO THE DISCRETION OF THE DISTRICT'S REPRESENTAT |
| | 7. | PRIOR TO A | ANY DEMOLITION WORK, CONTRACTOR SHALL PROTECT ALL EXISTING TREE & |
| | | "BLAZE OR/ FENCING S | ANGE" CONSTRUCTION SAFETY FENCING AT THE DRIPLINE OR PERIMETER. TH HALL BE SECURED WITH DRIVEN METAL STAKES. ALL TREE PROTECTION WORI |
| | 8. | REFER TO S | UBJECT TO THE DISCRETION OF THE DISTRICT'S REPRESENTATIVE. PECIFICATIONS FOR ADDITIONAL CLEARING, GRUBBING, TOPSOIL STOCKPILI |
| | F | & OTHER P | ERTINENT INFORMATION. DEMOLITION LEGEND |
| | F | SYM | DESCRIPTION |
| | | 11 | LIMIT OF WORK |
| | (# | | KEY LEGEND CALLOUT - ITEMS TO BE DEMOLISHED AND REMOVED |
| | # | | KEY LEGEND CALLOUT - ITEMS TO REMAIN AND BE PROTECTED |
| | < | \sim | KEY LEGEND CALLOUT - BID ALTERNATE ITEMS |
| | | | SURFACE VEGETATION TO BE REMOVED PER SPECIFICATIONS. REFER TO N |
| | 7 | | 5. REFER TO EARTHWORK SPECIFICATIONS FOR INFORMATION. DECOMPOSED GRANITE, INFIELD FINES, AB &/OR SAND TO BE REMOVED I |
| | | | SPECIFICATIONS. REMOVE EXCESS SOIL FROM SITE & DISPOSE IN LEGAL MANNER. REFER TO EARTHWORK SPECIFICATIONS FOR INFORMATION. DEMOLISH AND REMOVE EXISTING HARDSCAPE PAVING INCLUDING BASE |
| | | | MATERIAL. CONTRACTOR TO DISPOSE OF IN A LEGAL MANNER. |
| | Ø | <u>~</u> ~~ | TEMPORARY CONSTRUCTION FENCING |
| | ~ | | DEMOLISH AND REMOVE EXISTING CURB, UTILITY LINE, AND/OR FENCE, INCLUDING POSTS, FABRIC, CURBS, EDGEBANDS AND FOOTINGS |
| | - | | SAWCUT (TO NEAREST JOINT WHEN IN CONCRETE) |
| | | // | LIMIT OF CLEAR AND GRUB |
| | ſ | \bigotimes | TREE SHALL BE DEMOLISHED AND REMOVED |
| | | P | TREE TO REMAIN AND BE PROTECTED, REFER TO SPECIFICATIONS |
| | | | BE PROTECTED OR RELOCATED |
| | A B | | FENCE / GATE TO REMAIN AND BE PROTECTED. BUILDING TO REMAIN AND BE PROTECTED. |
| | C | | HARDSCAPE TO REMAIN AND BE PROTECTED. |
| | D | | CATCH BASINS OR DRAIN STRUCTURES INCLUDING LINES TO REMAIN AN CTED. THE OUTLET PIPES OF THESE CATCH BASINS ARE TO REMAIN AND |
| | | ELEVATIO | ED. CONTRACTOR TO ADJUST RIM ELEVATION TO PROPOSED FINISH GRAIN IF REQUIRED. |
| | E | | ELECTRICAL, COMMUNICATION, AND DATA LINES AND COMPONENTS TO AND BE PROTECTED. REFER TO ELECTRICAL PLANS FOR INFORMATION. |
| CH = 28 / CH = 2 | F | | UTILITY BOX AND UTILITY LINES TO REMAIN AND BE PROTECTED. CTOR TO RESET BOX TO MATCH PROPOSED FINISH GRADE. |
| | G Н | _ | BASKETBALL HOOP AND POST TO REMAIN AND BE PROTECTED. |
| | | | IRRIGATION EQUIPMENT TO REMAIN AND BE PROTECTED. |
| | Ū | | STRIPING TO REMAIN AND BE PROTECTED. AREAS WHERE NEW WORK SHALL BE RESTRIPED WITH SIMILAR PAINT TYPE, COLOR AND LAYOUT. |
| | K | _ | SIGNS TO REMAIN AND BE PROTECTED. |
| | | | BASKETBALL COURT AND EQUIPMENT SHALL REMAIN AND BE PROTECTED |
| | M | | POST, GUARD POST AND/OR BOLLARD TO REMAIN AND BE PROTECTED |
| | 0 | | SANITARY SEWER STRUCTURES INCLUDING LINES TO REMAIN AND BE ED. CONTRACTOR TO ADJUST RIM ELEVATION TO PROPOSED FINISH GRA |
| | | ELEVATIO | N IF REQUIRED. |
| | P Q | | BACKFLOW TO REMAIN AND BE PROTECTED. |
| | R | | EDGEBAND, AND/OR CURB, INCLUDING FOOTING TO REMAIN AND BE |
| | | | |
| | S T | | IRRIGATION MAINLINE SHALL REMAIN AND BE PROTECTED. |
| = | U | | TE SWALE TO REMAIN AND BE PROTECTED. |
| | V | EXISTING | FURNISHINGS TO REMAIN AND BE PROTECTED. |
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ITEMS TO BE DEMOLISHED



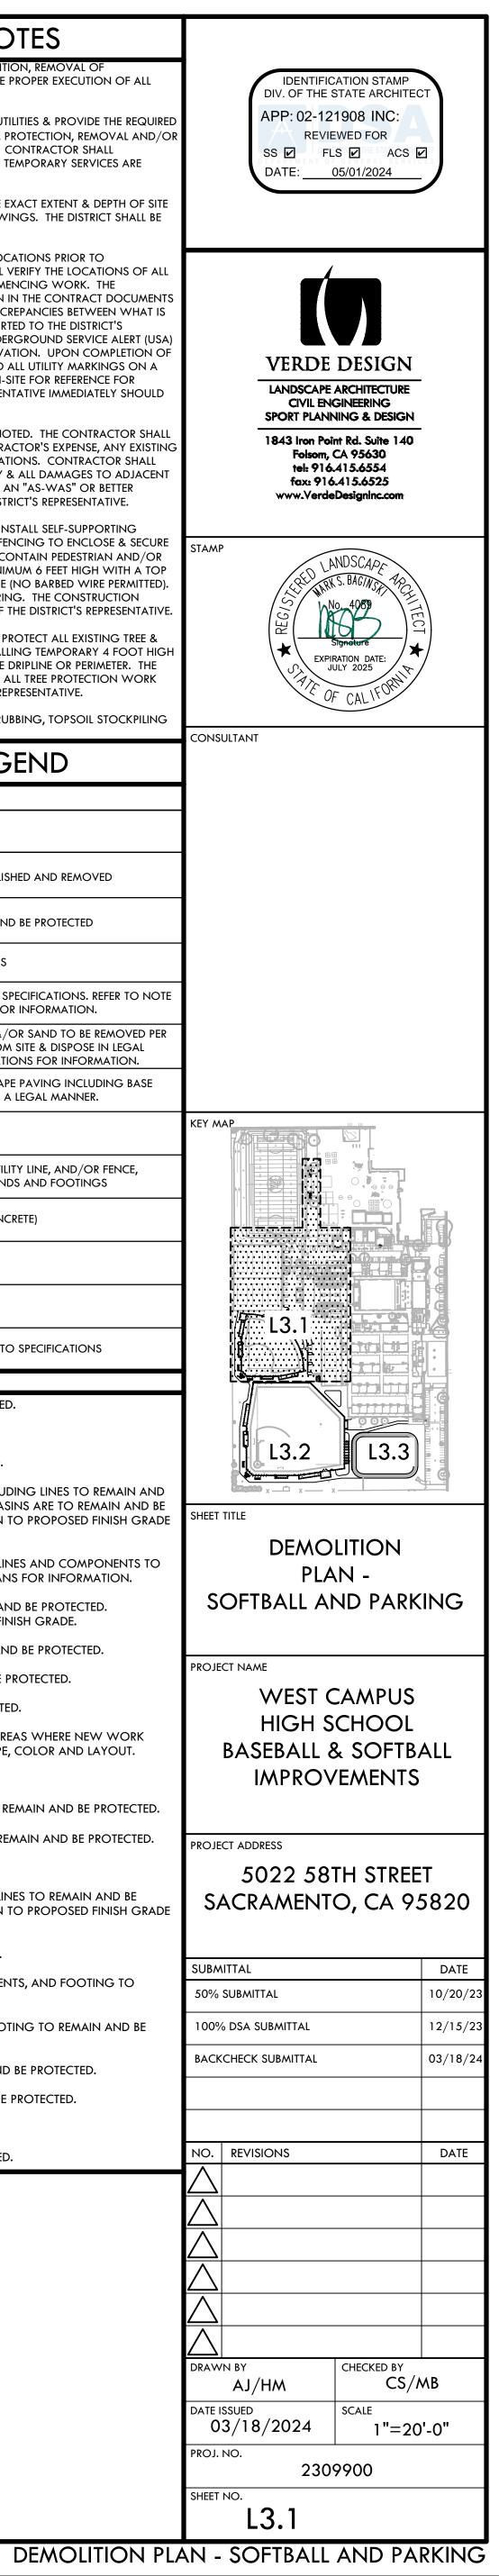
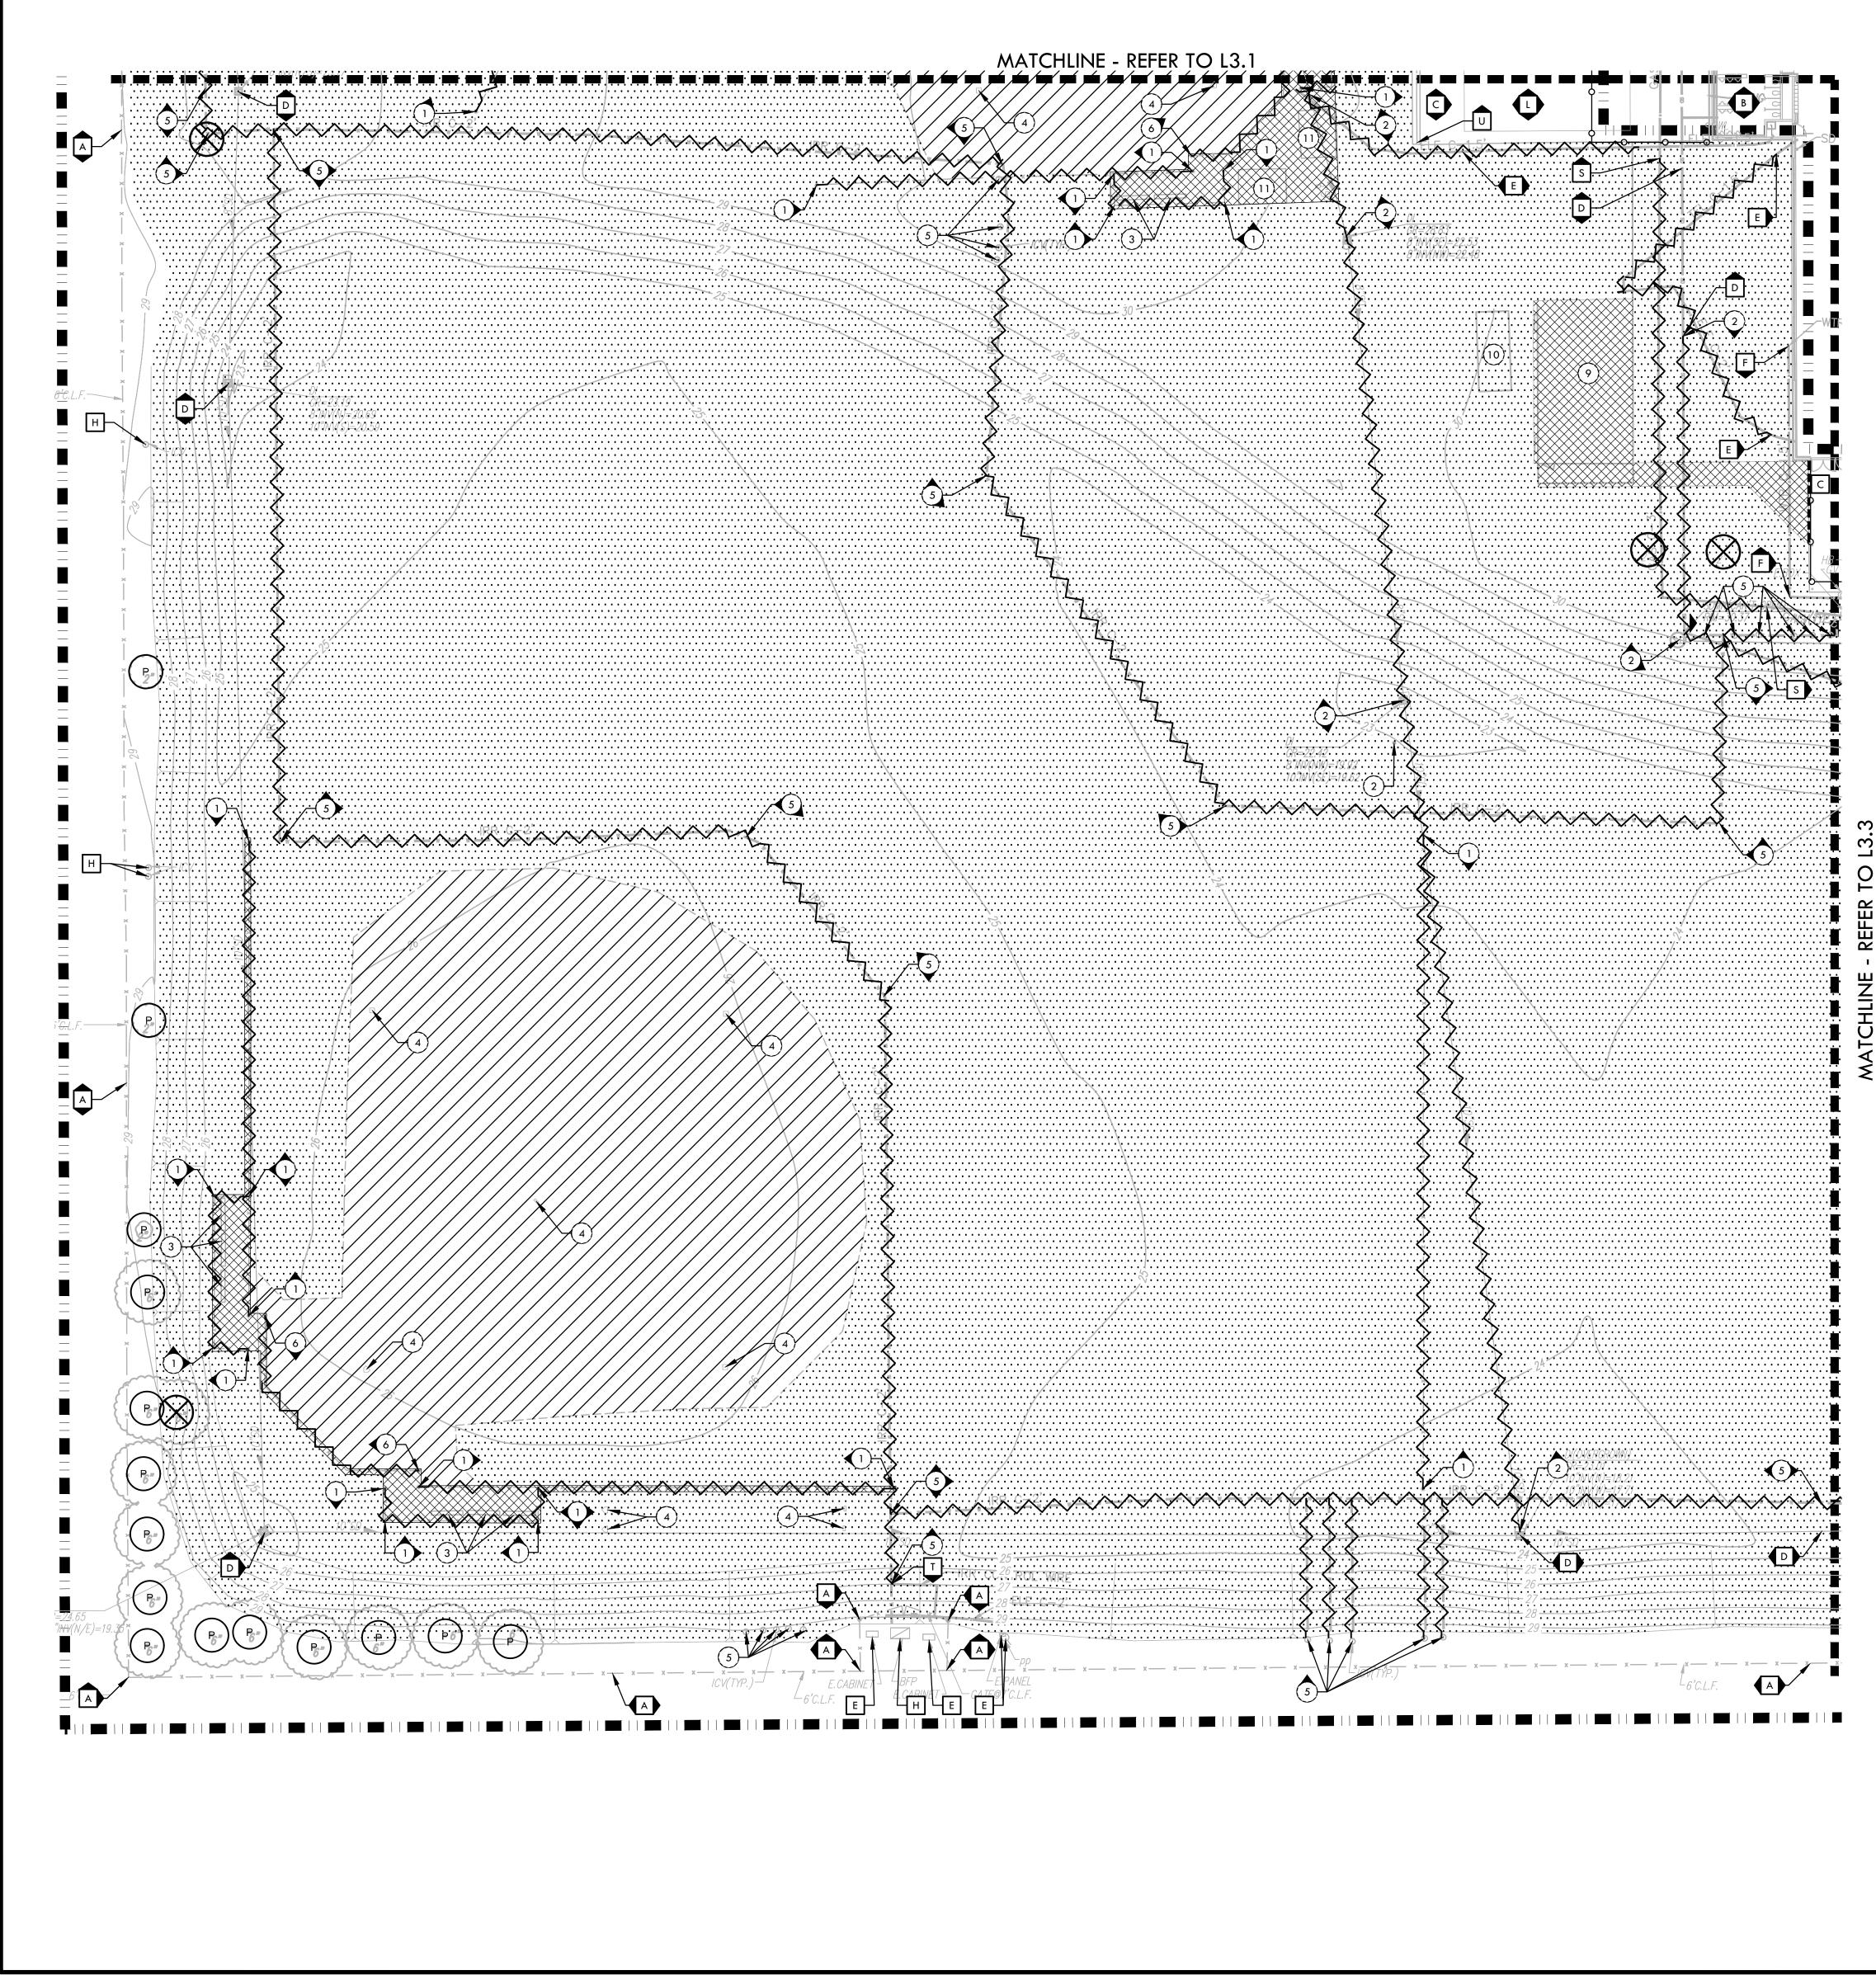
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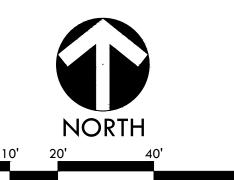
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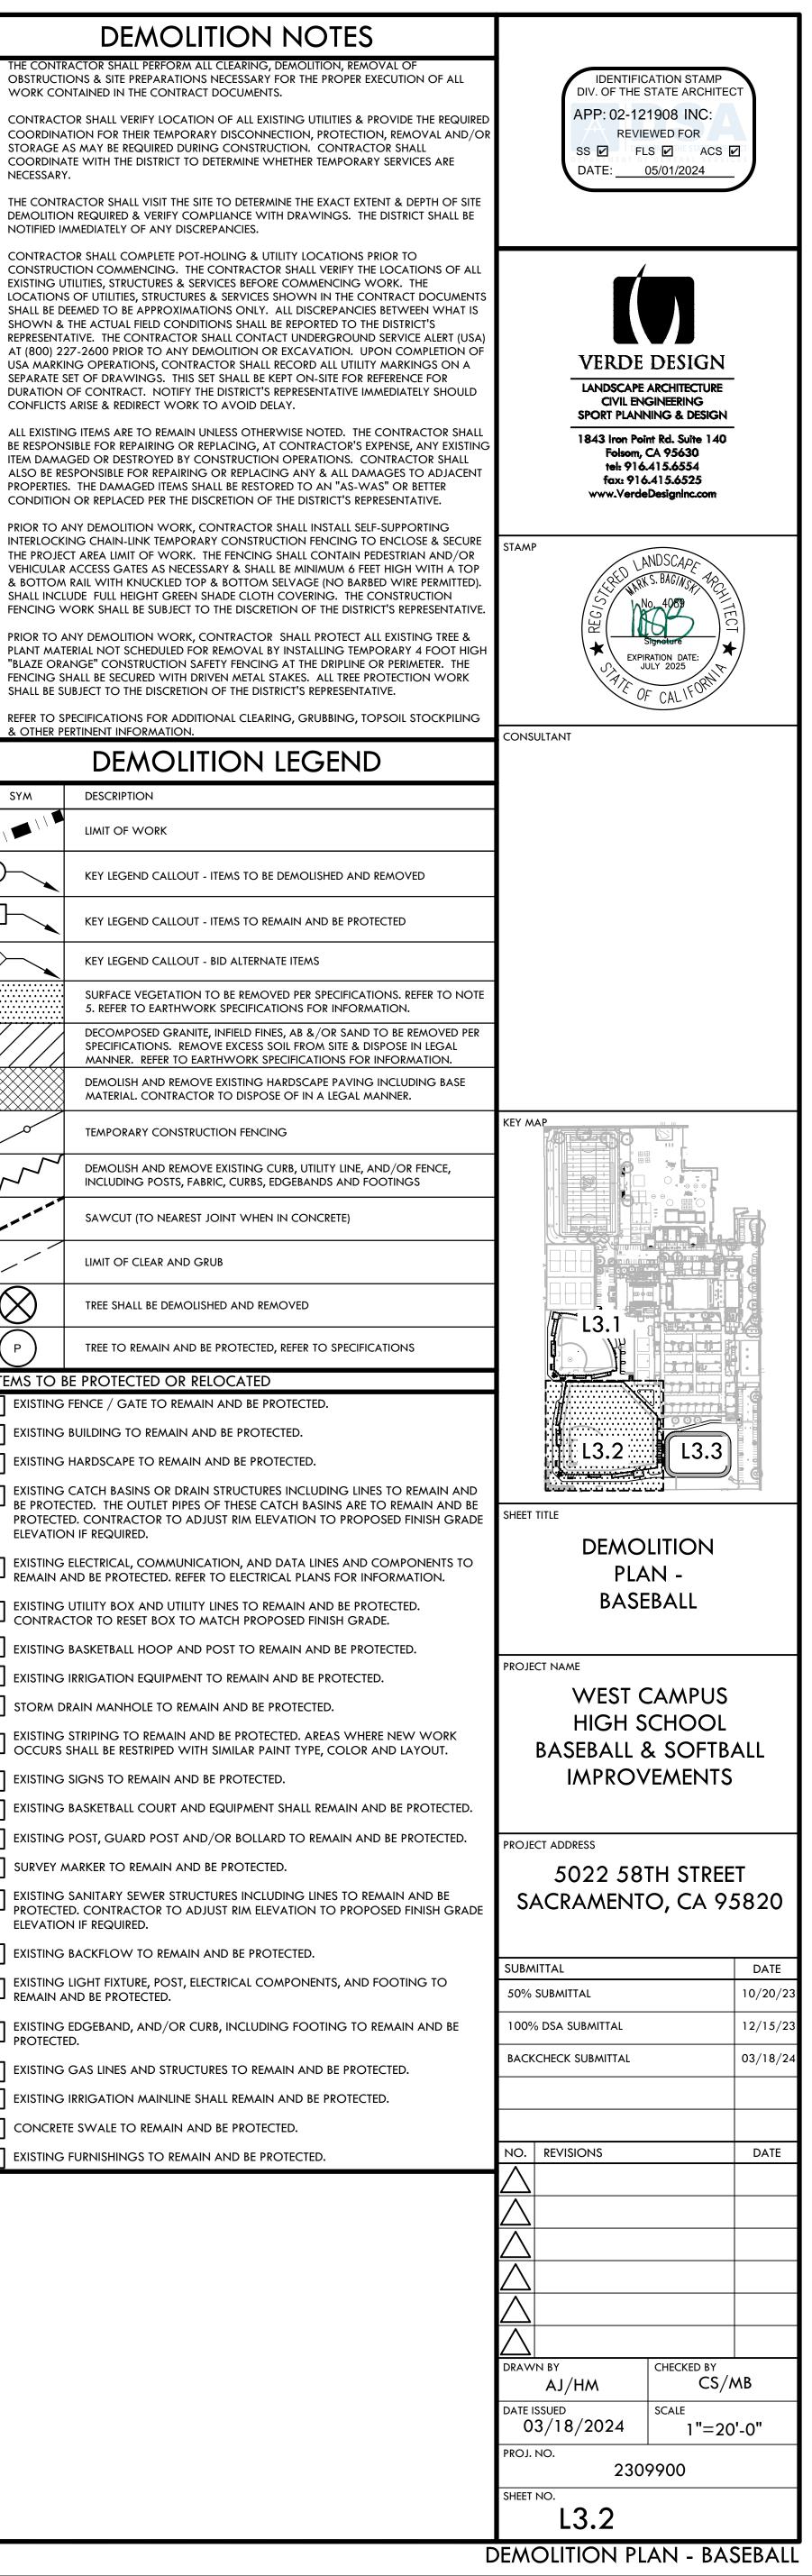
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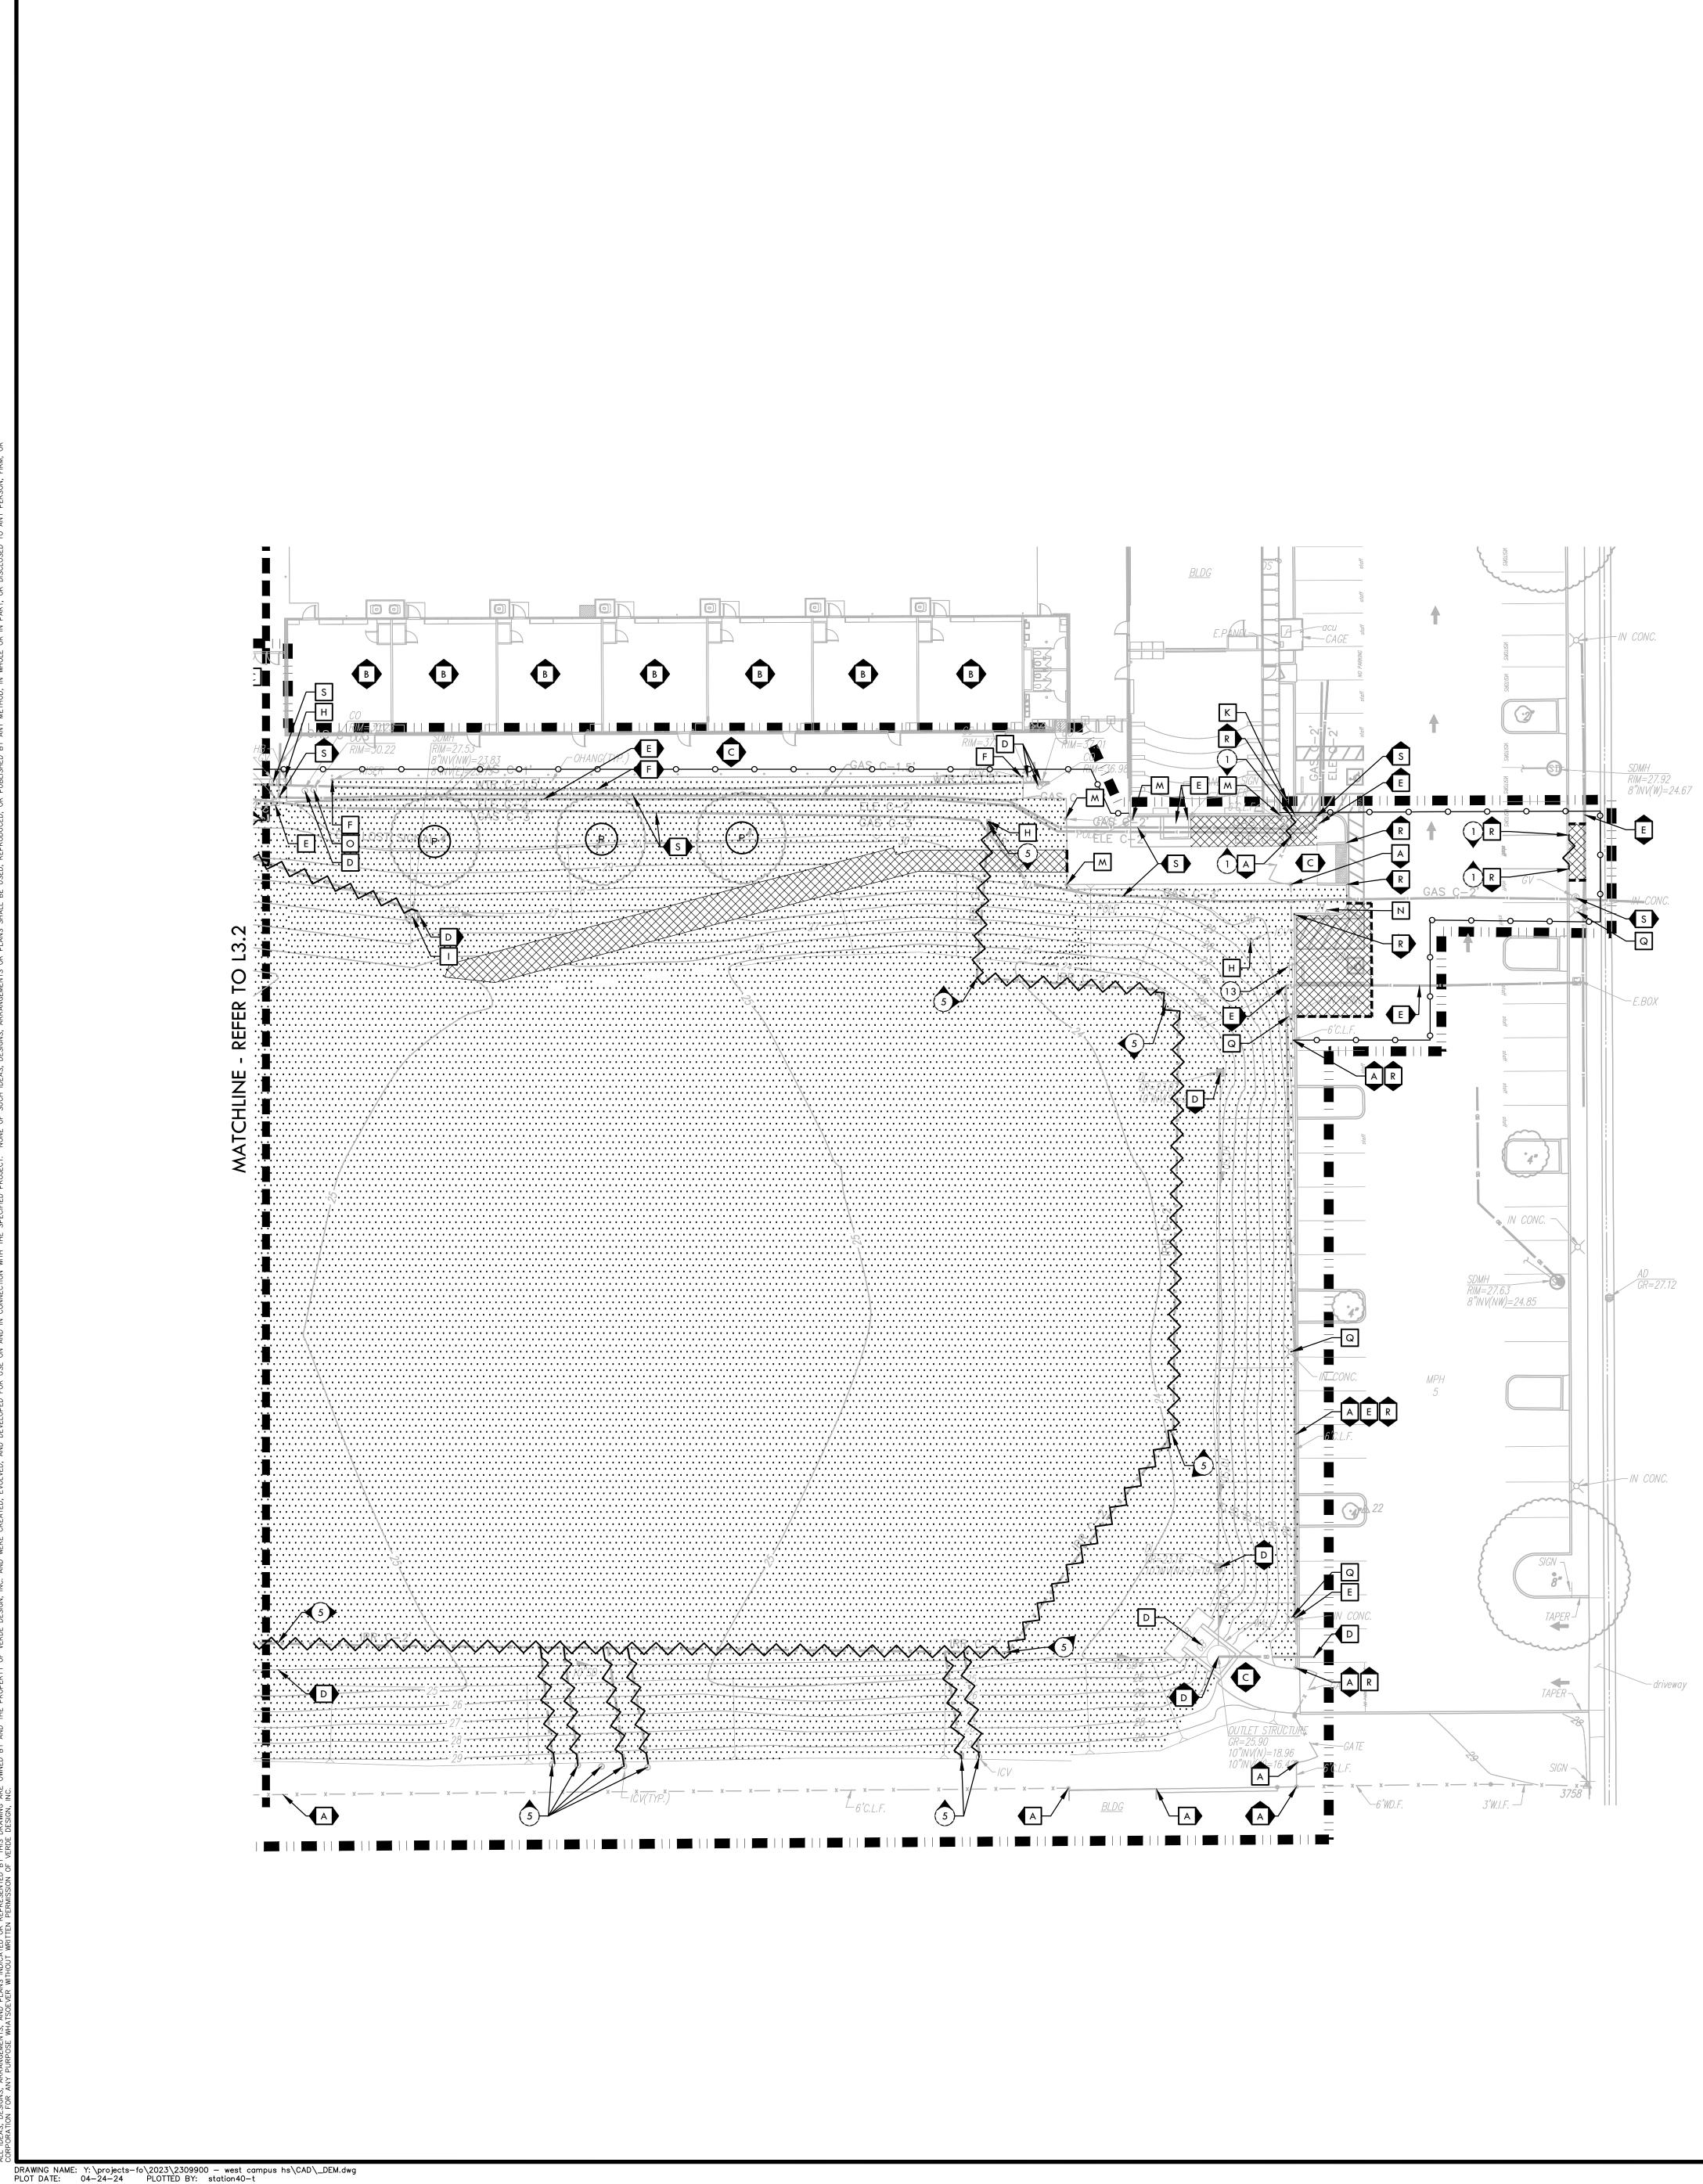
WORK CONTAINED IN THE CONTRACT DOCUMENTS.

NOTIFIED IMMEDIATELY OF ANY DISCREPANCIES.

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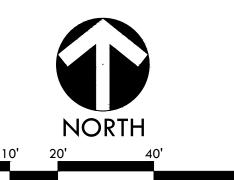
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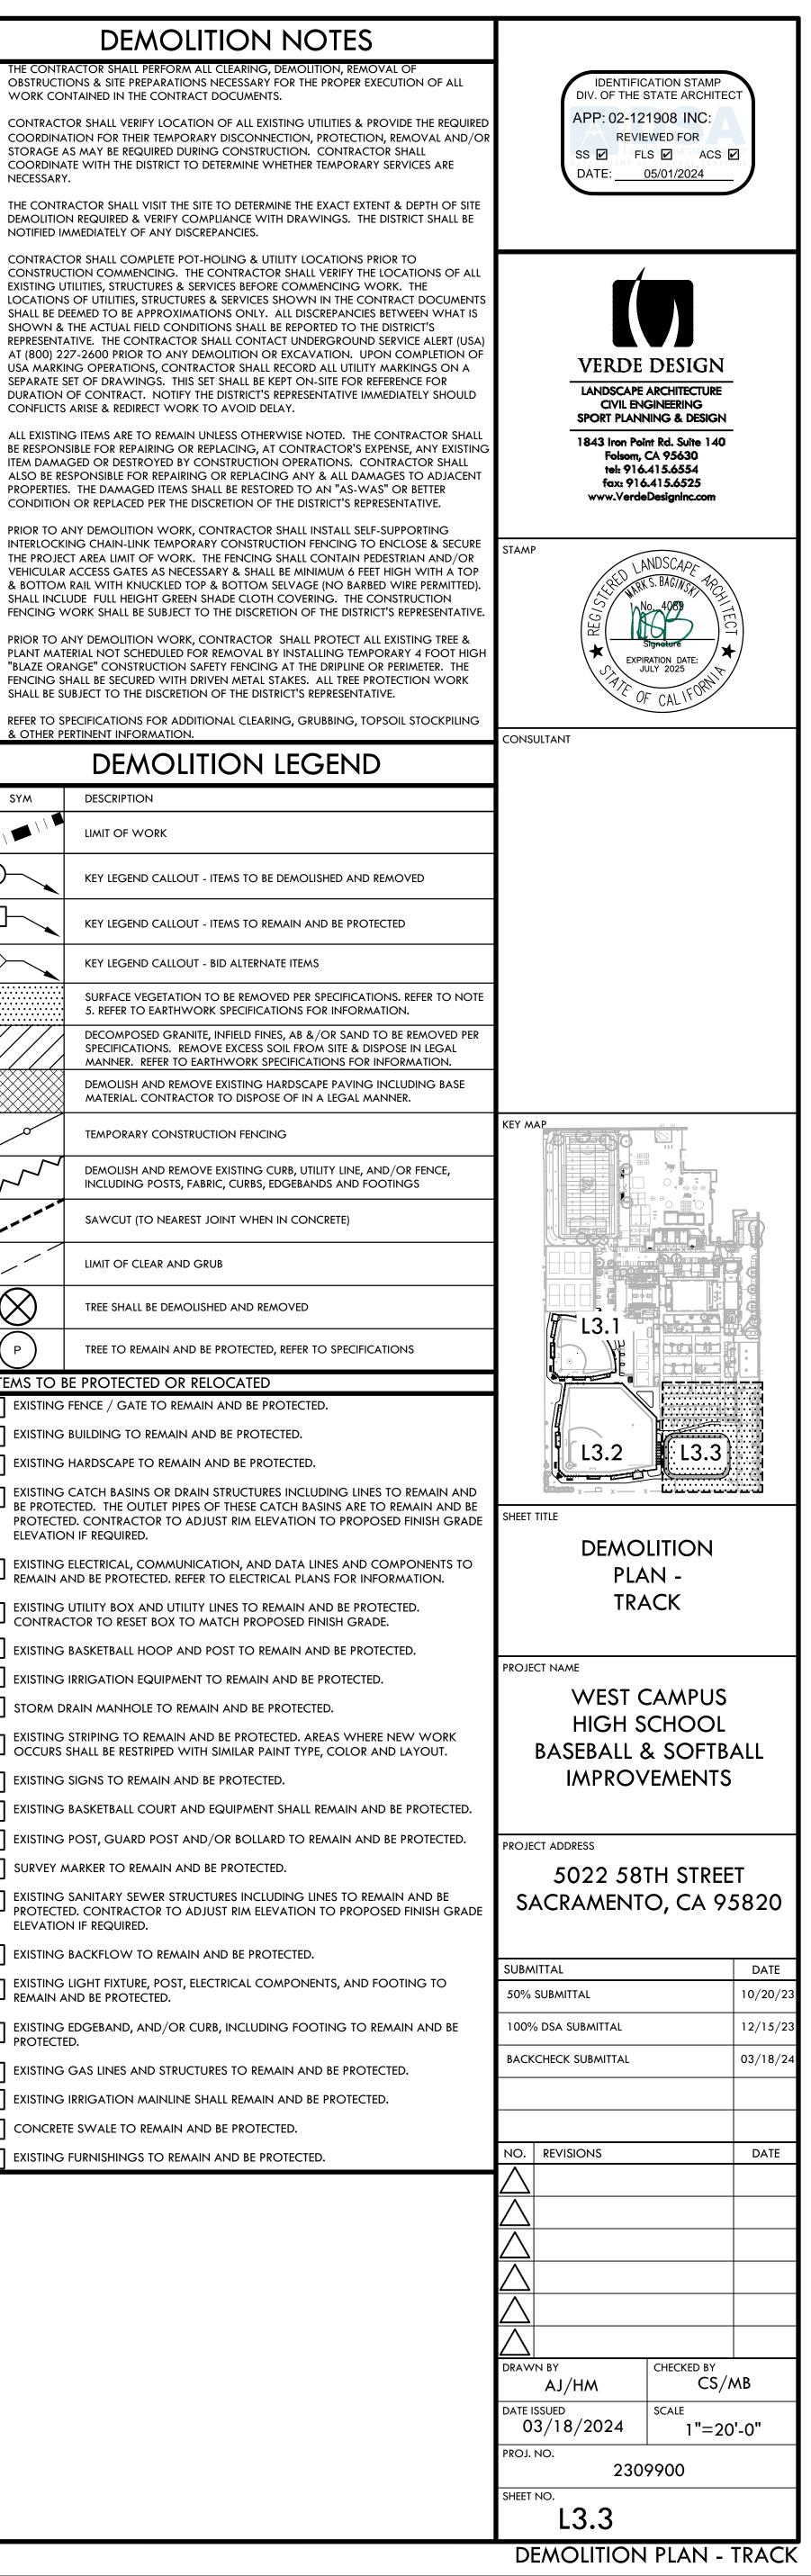
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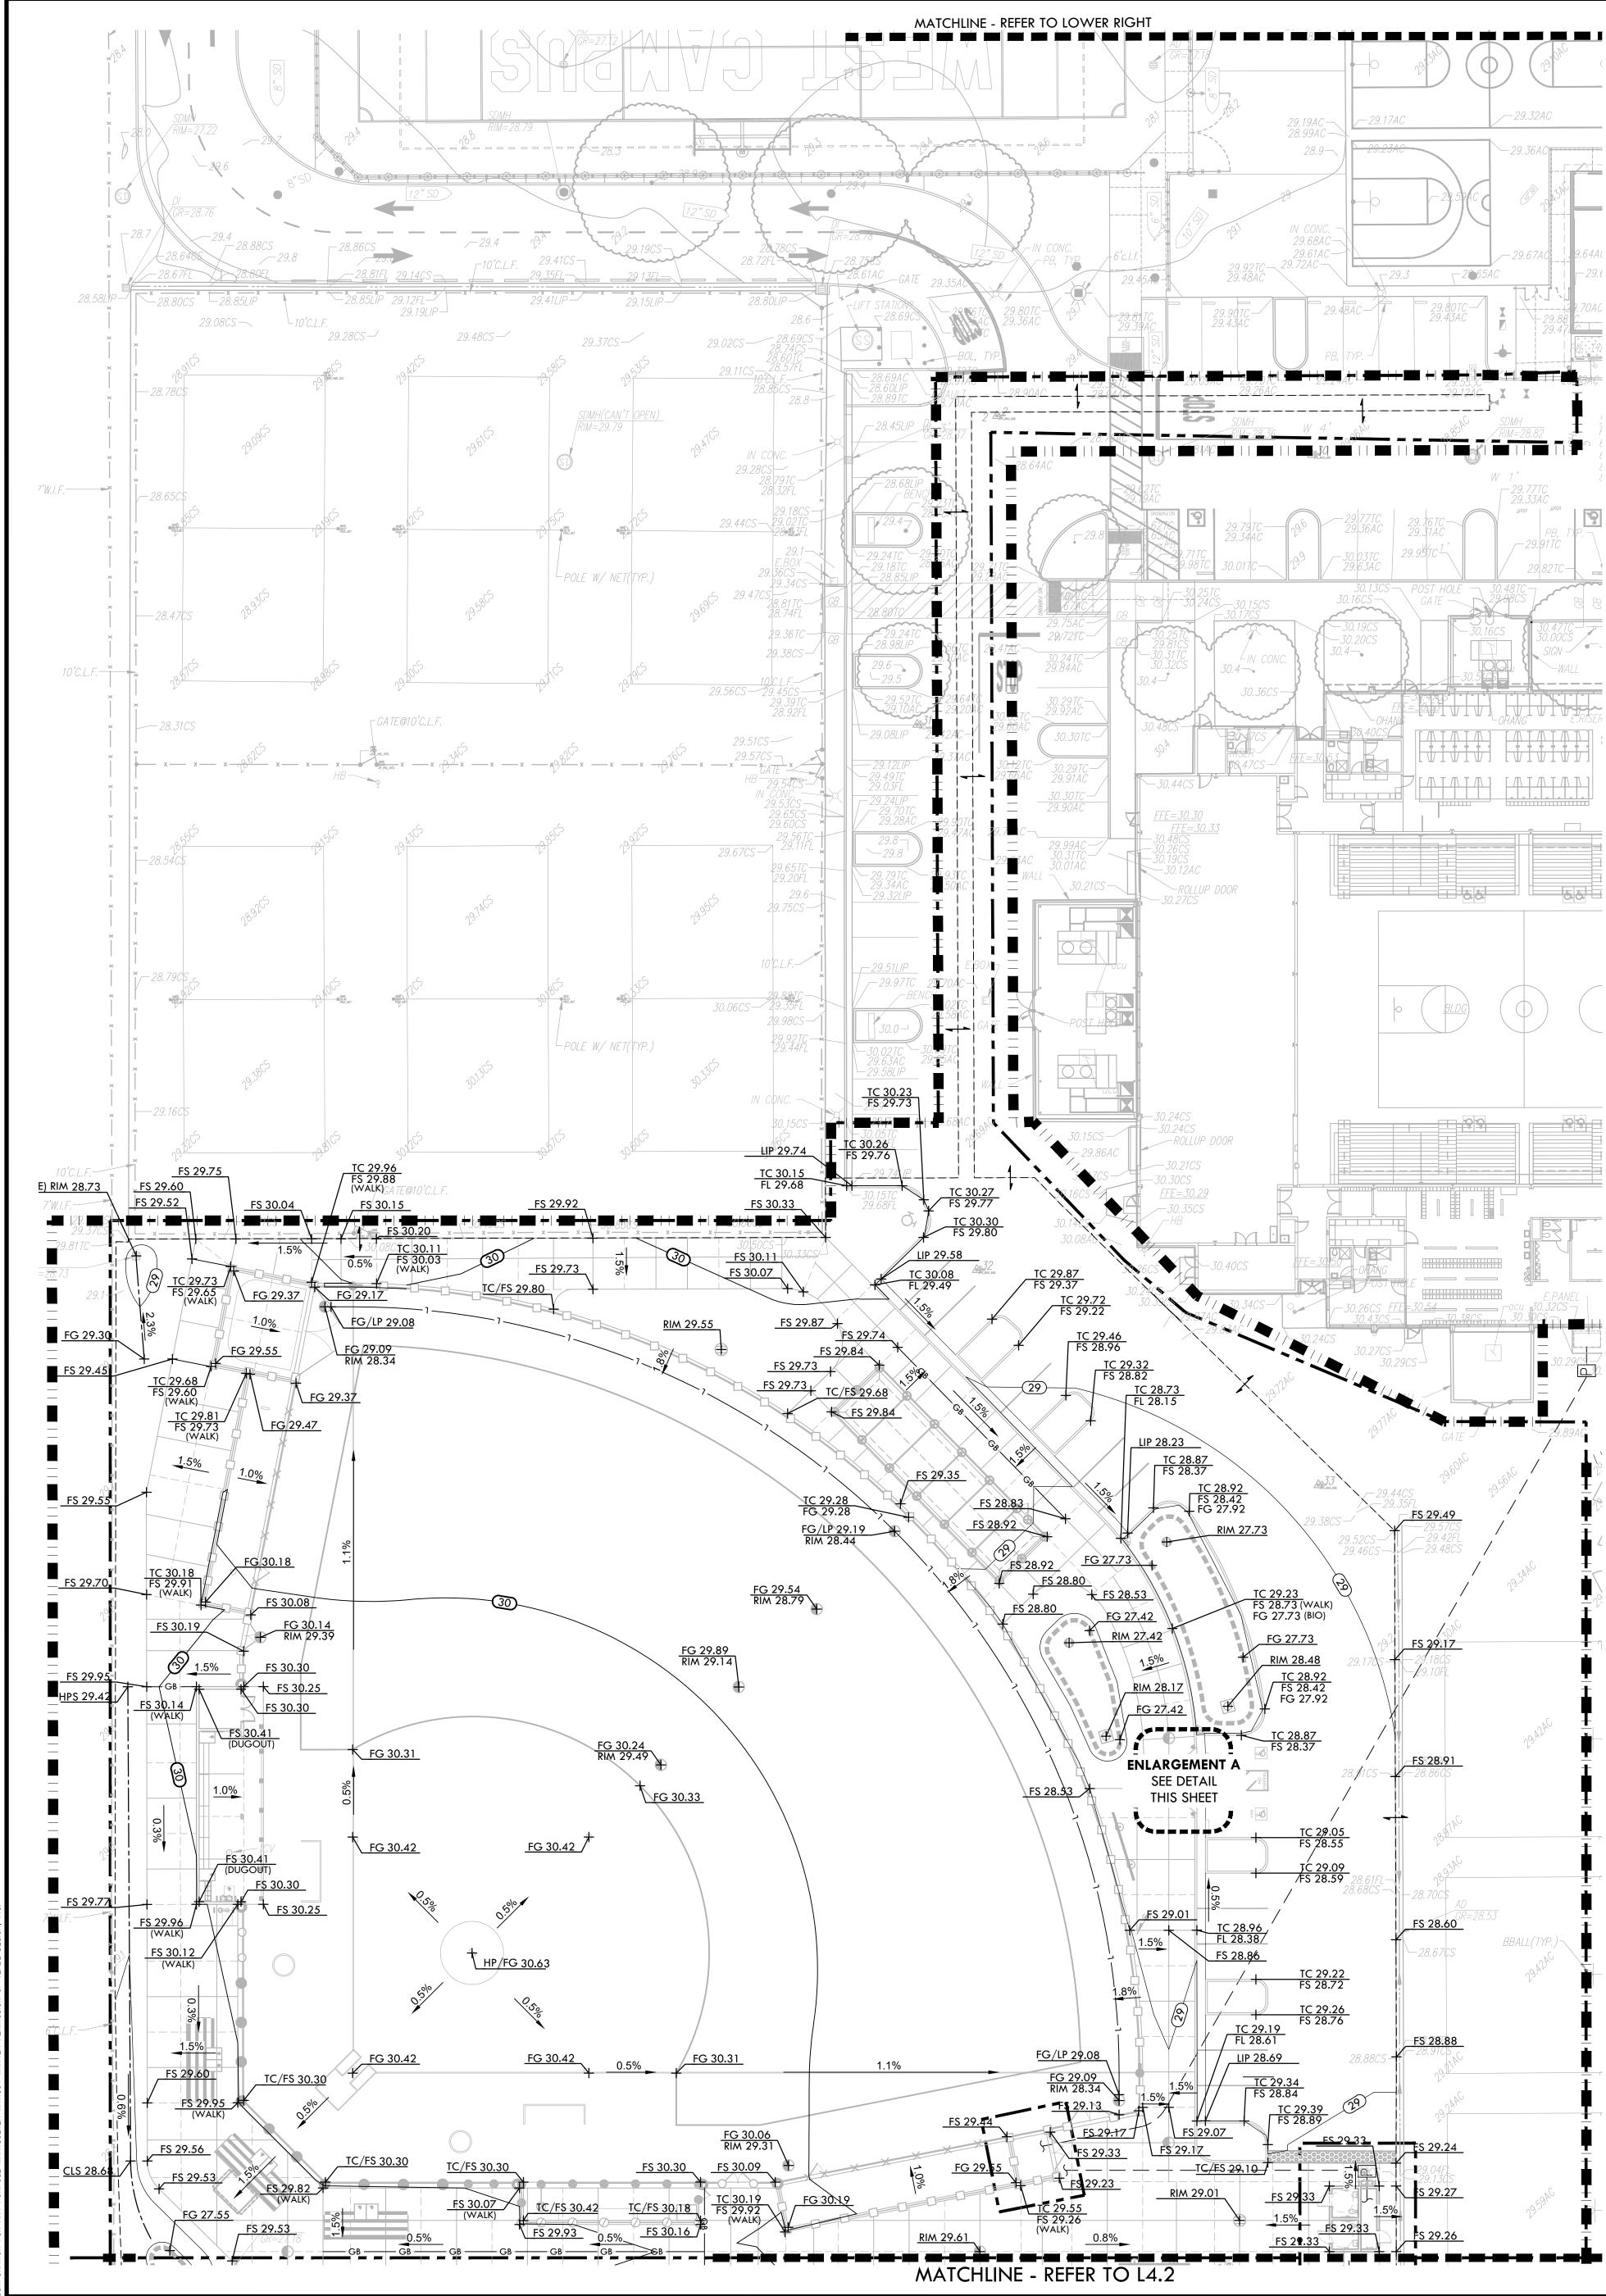
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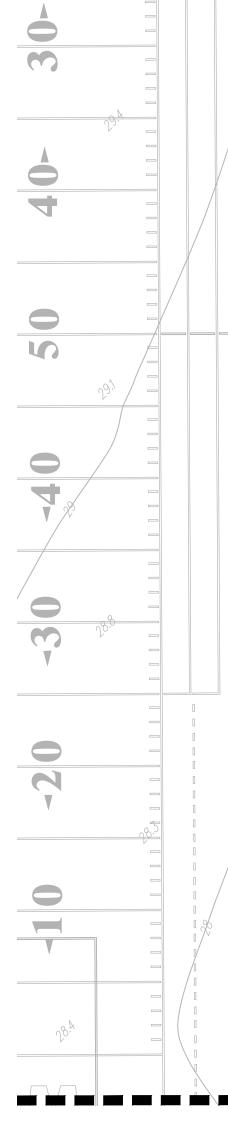
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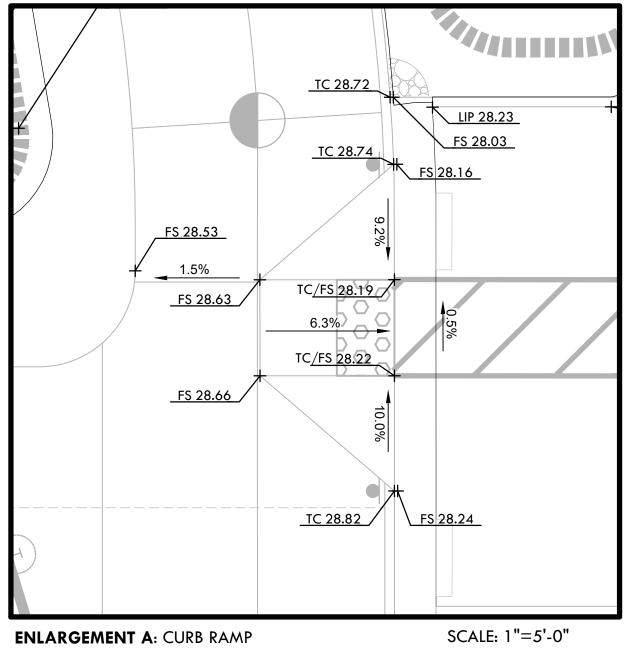







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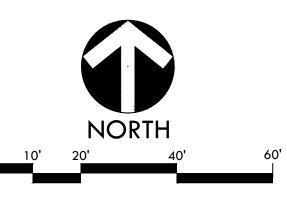
ENLARGEMENT A: CURB RAMP



GRADING NOTES


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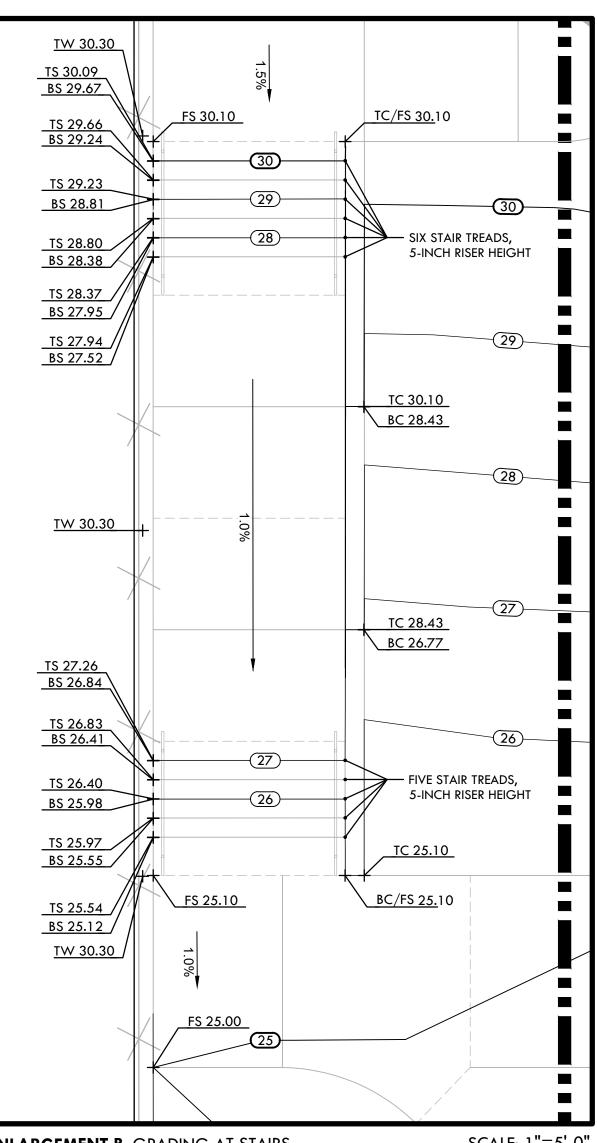
| | GRADING LEGEND |
|---------------|--|
| SYM | DESCRIPTION |
| | LIMIT OF WORK |
| | LIMIT OF GRADING - CONFORM TO EXISTING GRADES AT THIS LINI |
| GB GB | GRADE BREAK |
| 1 | LOW POINT OF FIELD / PERFORATED DRAIN LINE LOCATION |
| | CENTERLINE OF SWALE |
| | BOTTOM OF BIORETENTION BASIN, REFER TO DRAINAGE PLANS. |
| 25 | PROPOSED CONTOUR |
| FG 25.00 | PROPOSED FINISH GRADE ELEVATION OF SOFTSCAPE |
| FS 25.00 | PROPOSED FINISH SURFACE ELEVATION OF HARDSCAPE |
| FL 25.00 | PROPOSED FLOW LINE ELEVATION OF GUTTER |
| CLS 25.00 | CENTERLINE OF SWALE |
| HPS 25.00 | HIGH POINT OF SWALE |
| LP 25.00 | LOW POINT OF SWALE / FIELD |
| LIP 25.00 | PROPOSED LIP OF GUTTER ELEVATION |
| RIM 25.00 | LOW POINT/ RIM ELEVATION OF DRAIN |
| TC 25.50 | TOP OF CURB |
| TW 25.00 | TOP OF WALL ELEVATION |
| TS 25.00 | TOP OF STAIR ELEVATION |
| BS 25.00 | BOTTOM OF STAIR ELEVATION |
| (E) RIM 25.00 | EXISTING DRAIN INLET RIM THAT IS REMAINING AT EXISTING ELEVA |
| 1, | CONFORM TO EXISTING GRADE |
| ~~ | FLOW DIRECTION IN SOFTSCAPE |
| <u>1.00%</u> | SLOPE AND DIRECTION |
| 29 | EXISTING CONTOUR |
| 29.1 | EXISTING ELEVATION |
| A | ADJUST EXISTING RIM ELEVATION TO PROPOSED GRADE |
| В | EXISTING STRUCTURE TO BE BURIED IN PLACE |
| <u> </u> | |

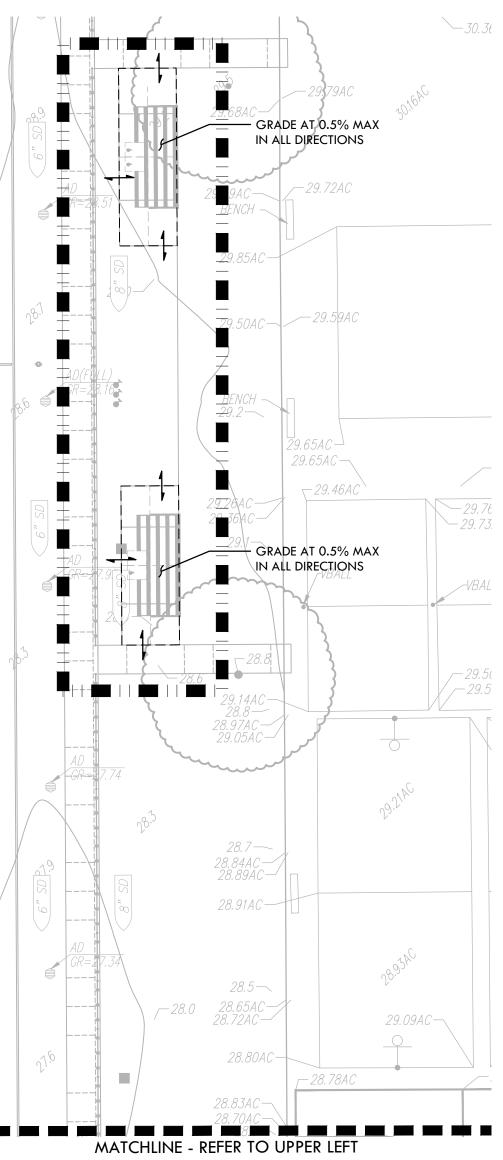

| OF S ARISE URES TURES THE 2600 G SET OF | IDENTIFICATION STAMP DIV. OF THE STATE ARCHITEC APP: 02-121908 INC: REVIEWED FOR SS ☑ FLS ☑ ACS ☑ DATE: 05/01/2024 | |
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| OUS RICT DELAY HT TO | VERDE DESIGN VERDE DESIGN LANDSCAPE ARCHITECTURE CIVIL ENGINEERING SPORT PLANNING & DESIGN 1843 Iron Point Rd. Suite 140 Folsom, CA 95630 tel: 916.415.6554 fax: 916.415.6525 www.VerdeDesignInc.com | |
| IE | STAMP | |
| | CONSULTANT | |
| | | |
| | KEY MAP | |
| | | |
| | SHEET TITLE GRADING PLAN - SOFTBALL & PARKIN | |
| | WEST CAMPUS HIGH SCHOOL BASEBALL & SOFTBA IMPROVEMENTS | |
| | 5022 58TH STREE SACRAMENTO, CA 95 SUBMITTAL 50% SUBMITTAL 100% DSA SUBMITTAL | DATE 10/20/23 12/15/23 |
| | | 03/18/24 DATE |
| | Image: Checked by control of the c | |
| NG | 03/18/2024 1"=20 PROJ. NO. 2309900 SHEET NO. L4.1 PLAN - SOFTBALL & PAI | |





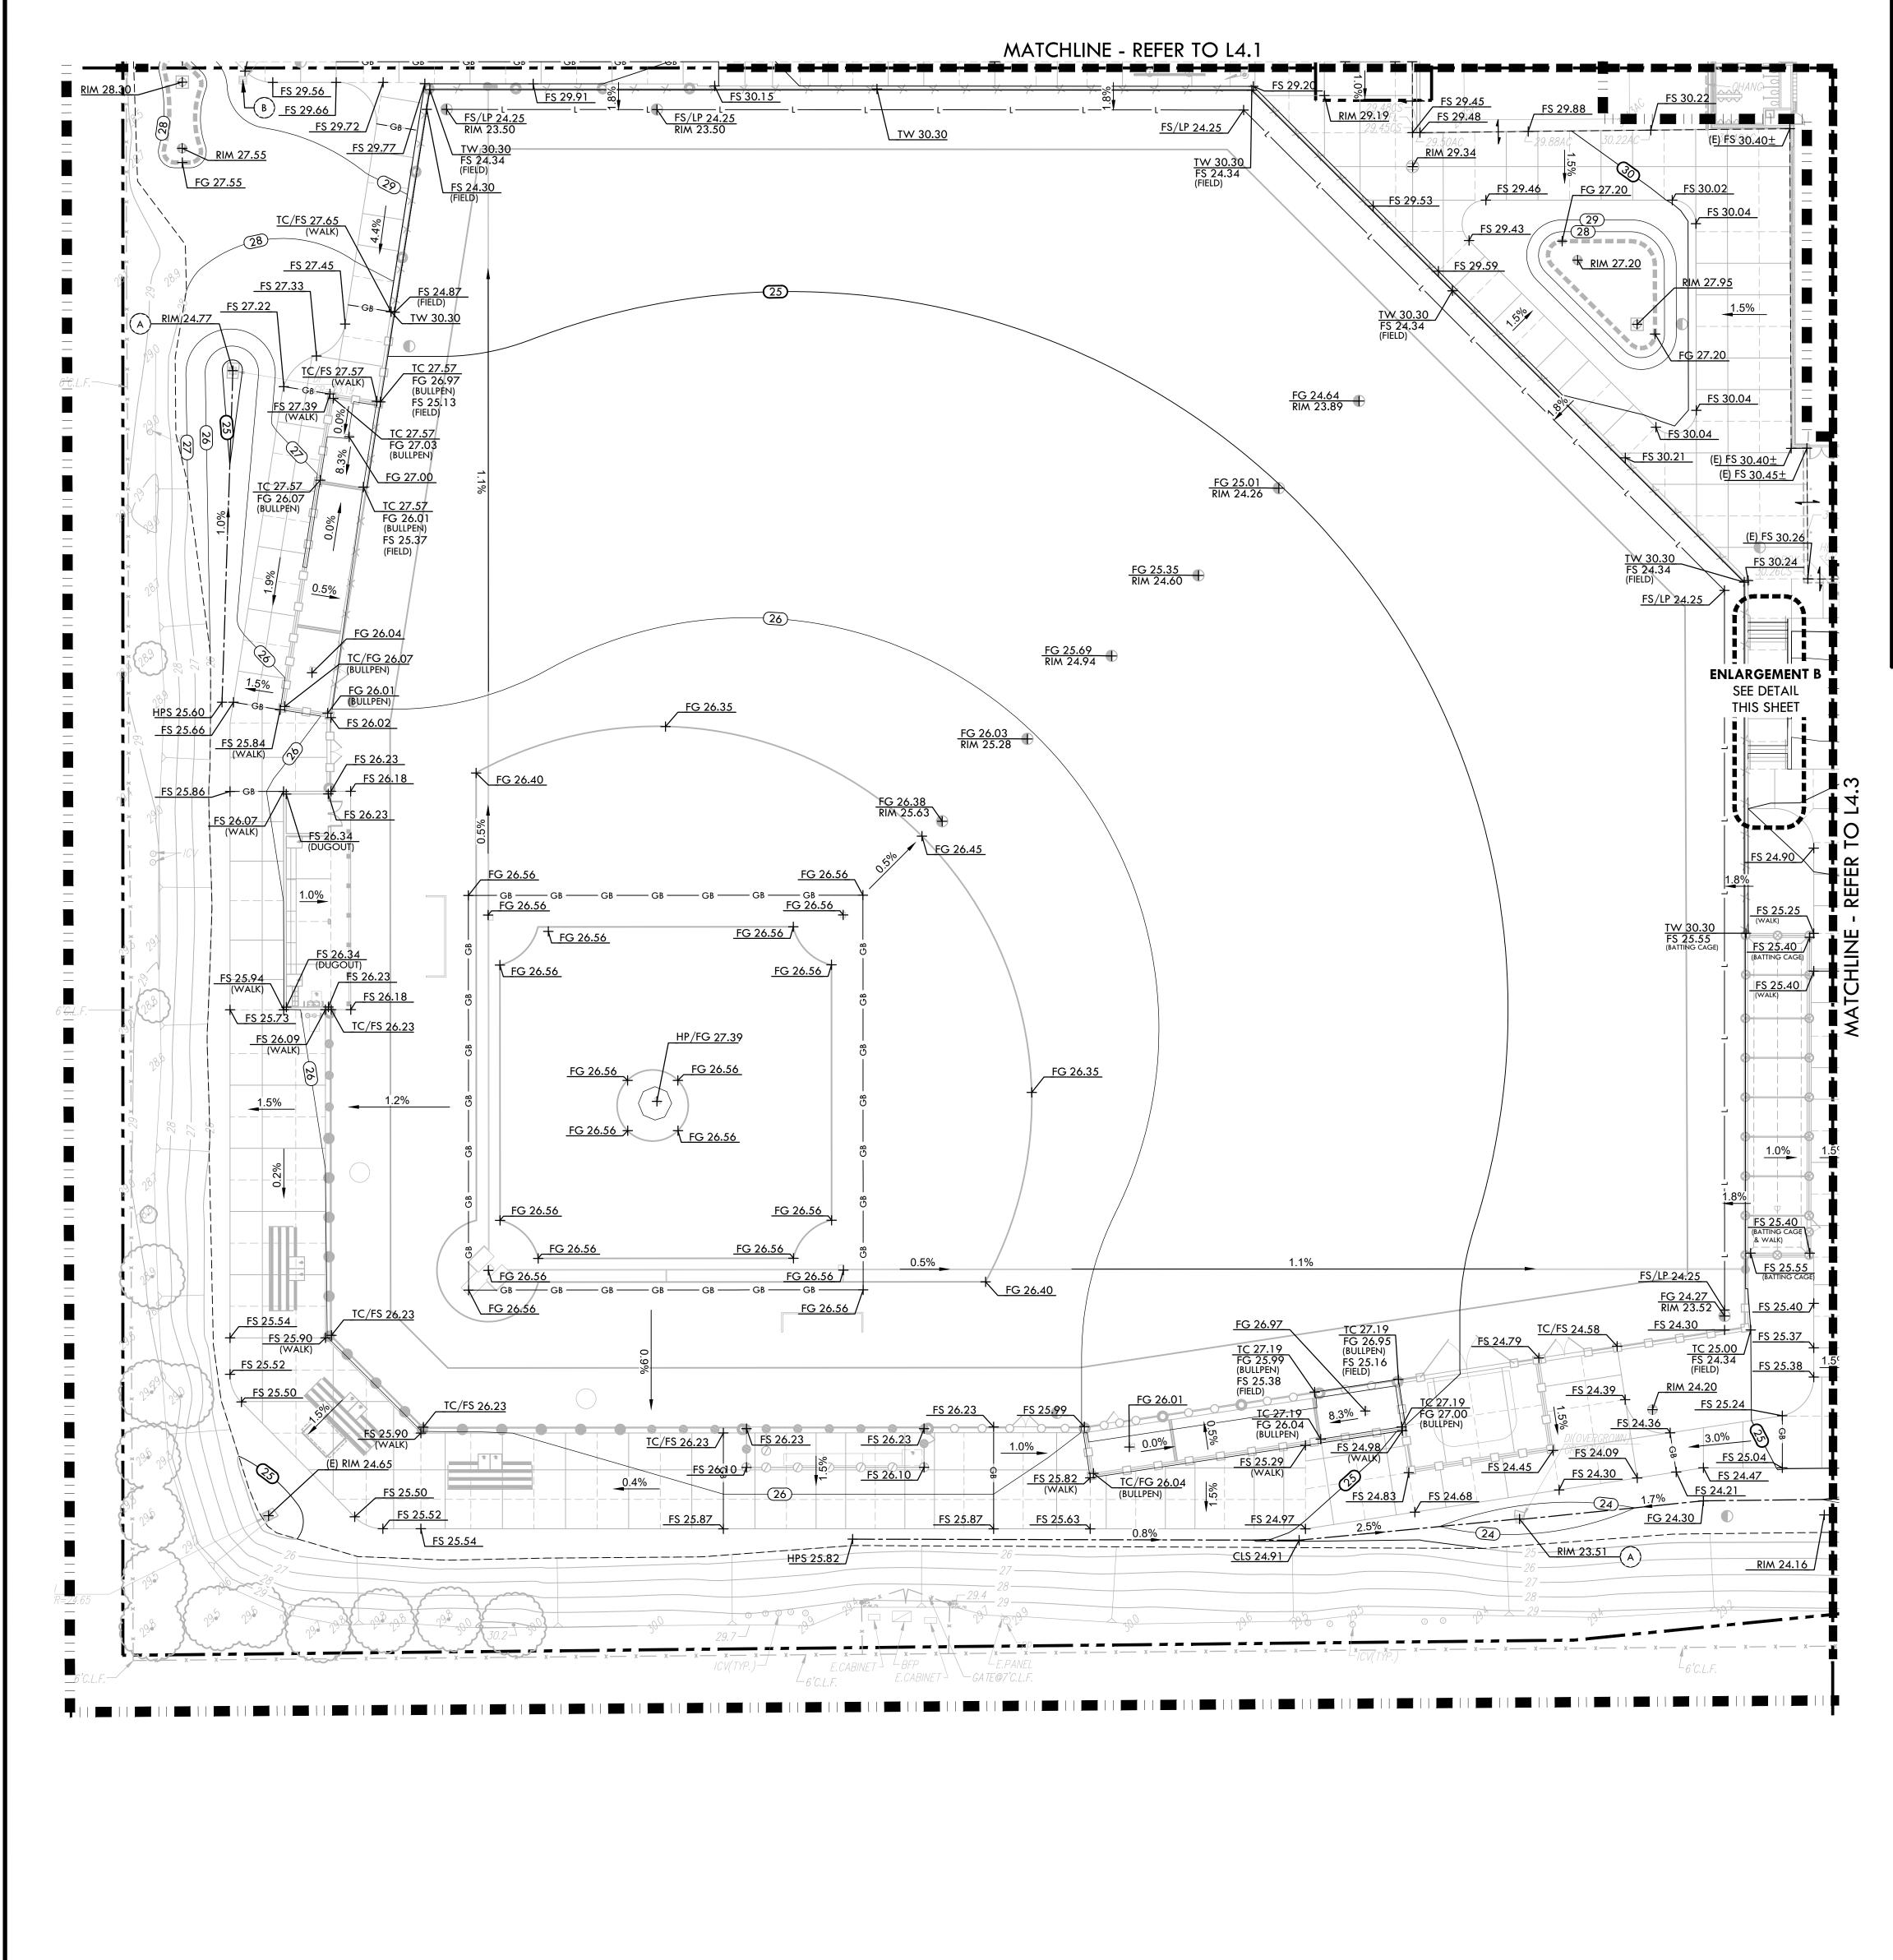

ENLARGEMENT B: GRADING AT STAIRS

SCALE: 1"=5'-0"


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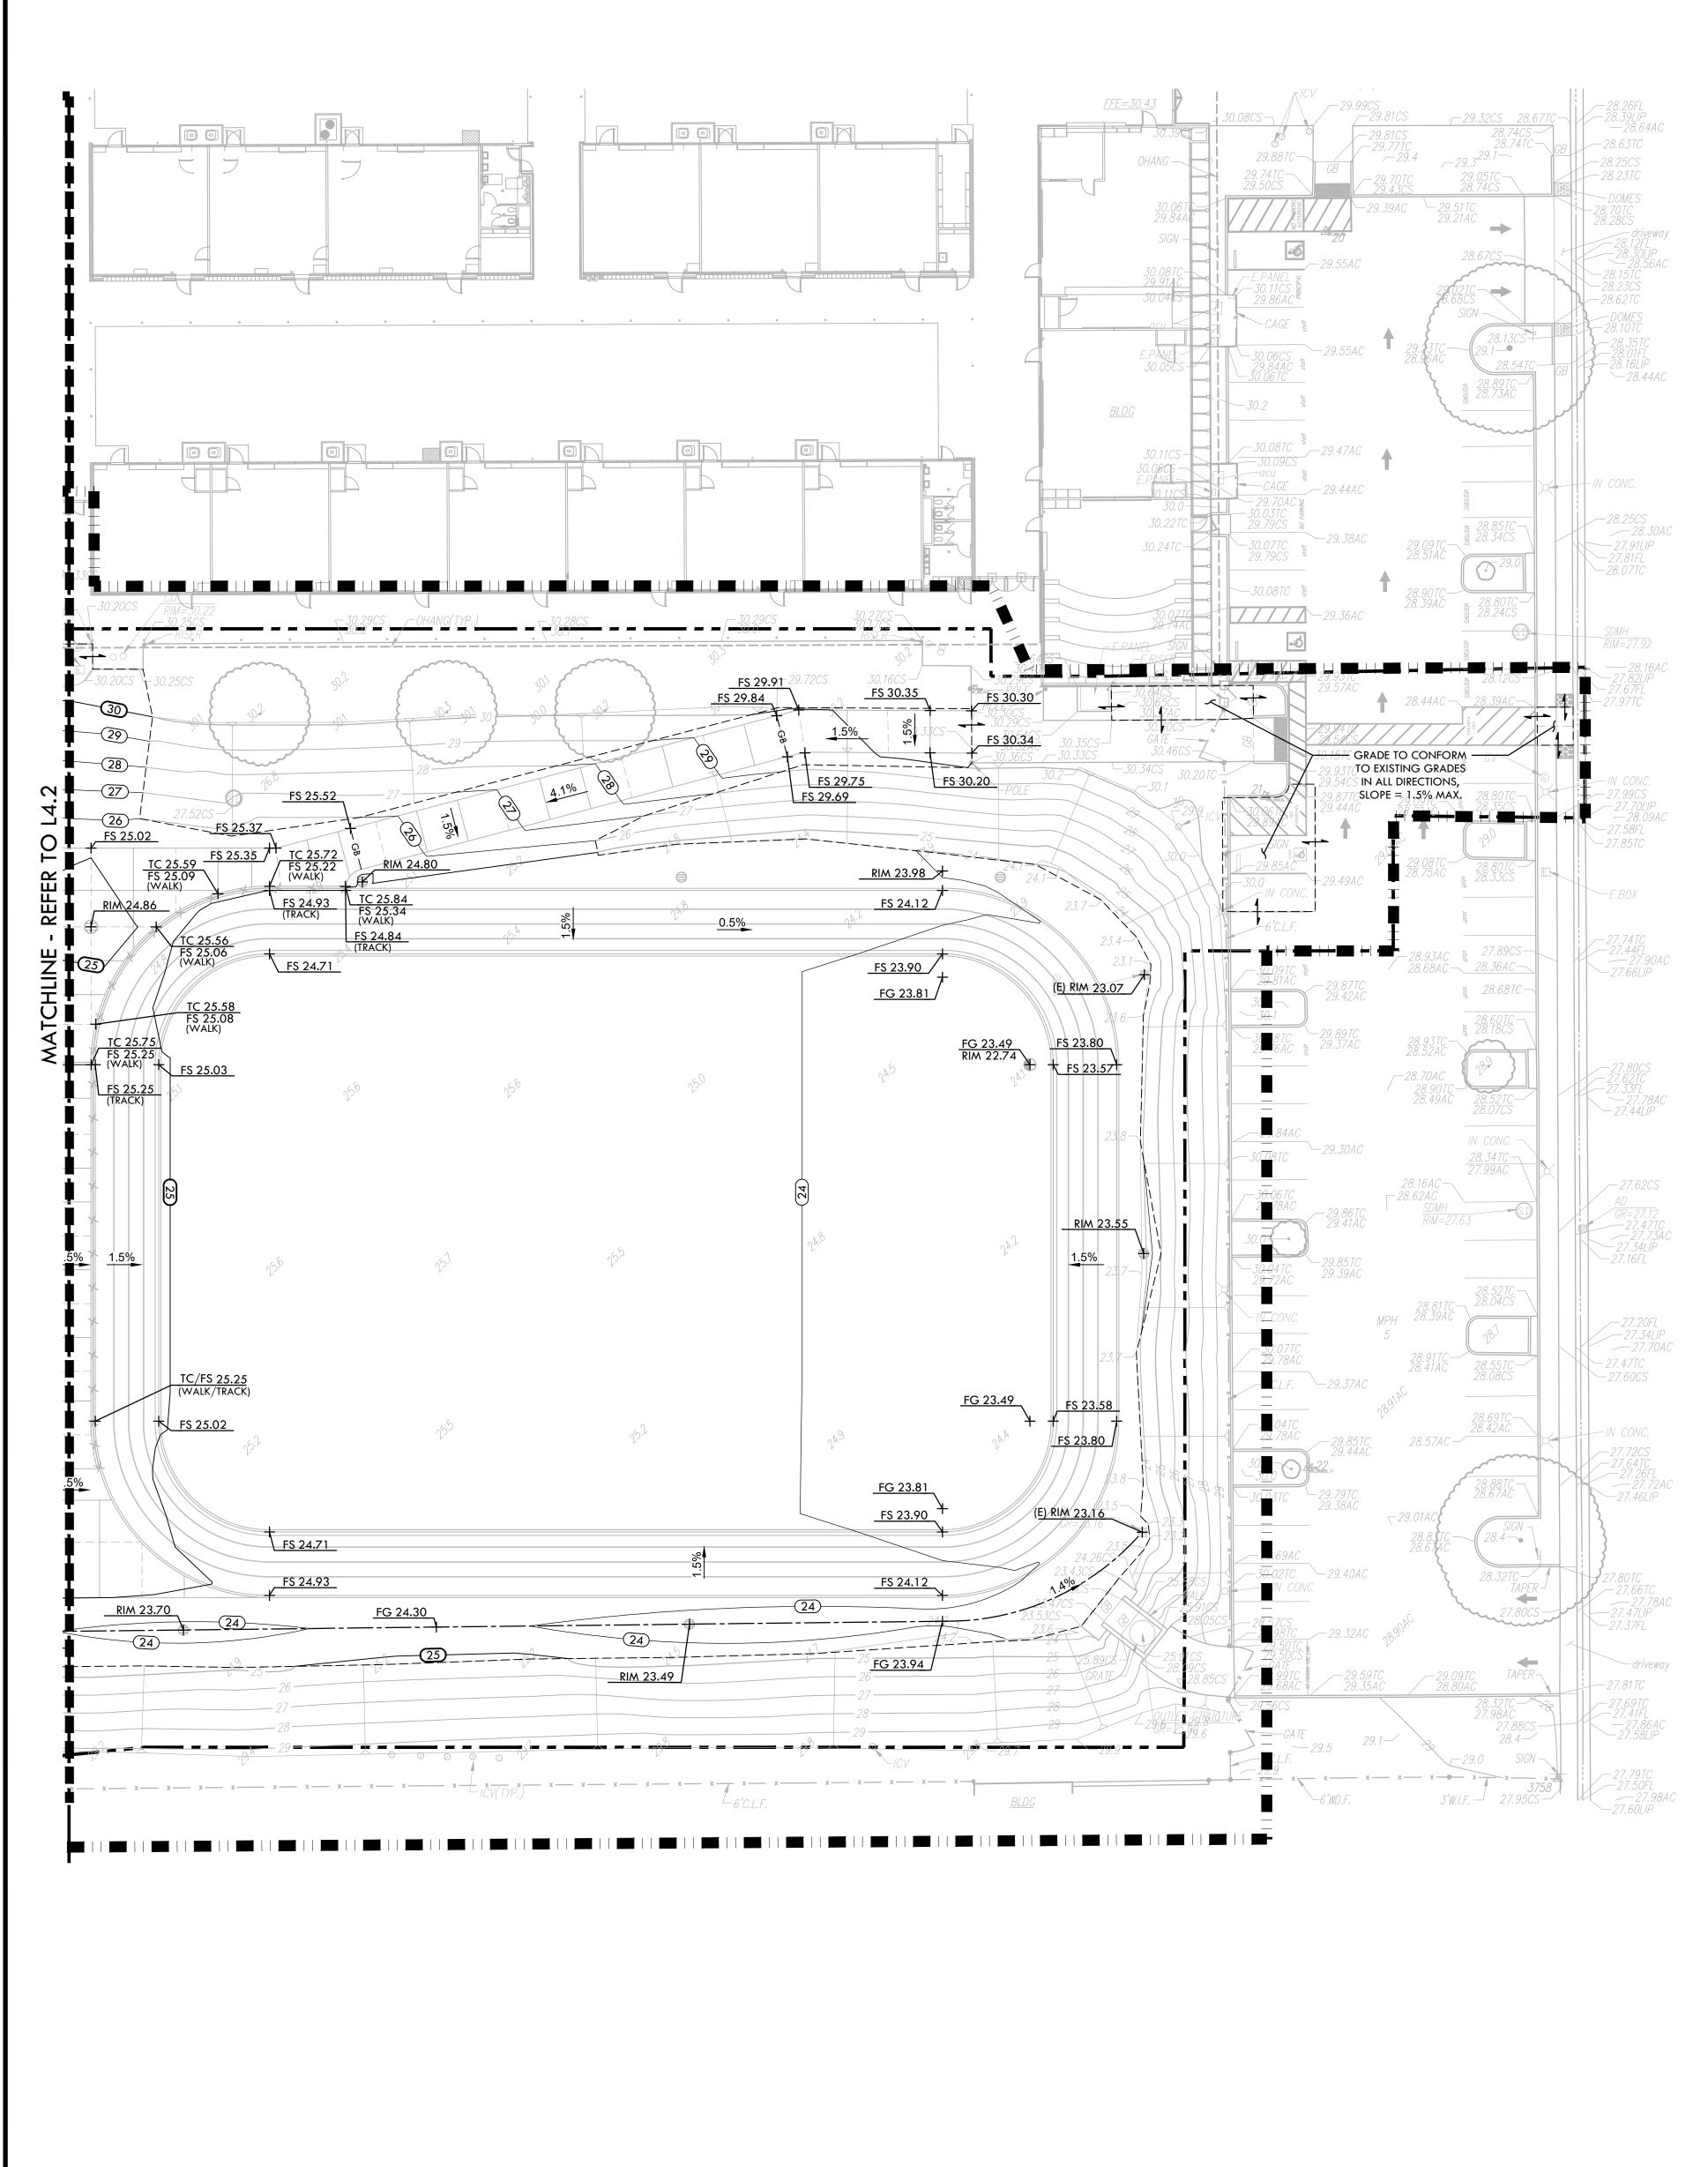
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| OF ARISE JRES URES THE 2600 G SET OF | IDENTIFICATION STAMP DIV. OF THE STATE ARCHITEC APP: 02-121908 INC: REVIEWED FOR SS I FLS ACS I DATE: 05/01/2024 | |
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| DUS RICT DELAY IT TO | VERDE DESIGN VERDE DESIGN LANDSCAPE ARCHITECTURE CIVIL ENGINEERING SPORT PLANNING & DESIGN 1843 Iron Point Rd. Suite 140 Folsom, CA 95630 tel: 916.415.6554 fax: 916.415.6525 www.VerdeDesignInc.com | |
| E | STAMP | |
| | CONSULTANT | |
| | KEY MAP | |
| | SHEET TITLE GRADING PLAN - BASEBALL | |
| | PROJECT NAME WEST CAMPUS HIGH SCHOOL BASEBALL & SOFTBA IMPROVEMENTS PROJECT ADDRESS 5022 58TH STREE SACRAMENTO, CA 95 | T |
| | SUBMITTAL 50% SUBMITTAL 100% DSA SUBMITTAL BACKCHECK SUBMITTAL | DATE 10/20/23 12/15/23 03/18/24 |
| | | DATE |
| | DRAWN BY DK DATE ISSUED 03/18/2024 PROJ. NO. 2309900 SHEET NO. L4.2 GRADING PLAN - BAS | '-0" |
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DRAWING NAME: Y:\projects-fo\2023\2309900 - west campus hs\CAD_GRD-C3D.dwg PLOT DATE: 04-24-24 PLOTTED BY: station40-t


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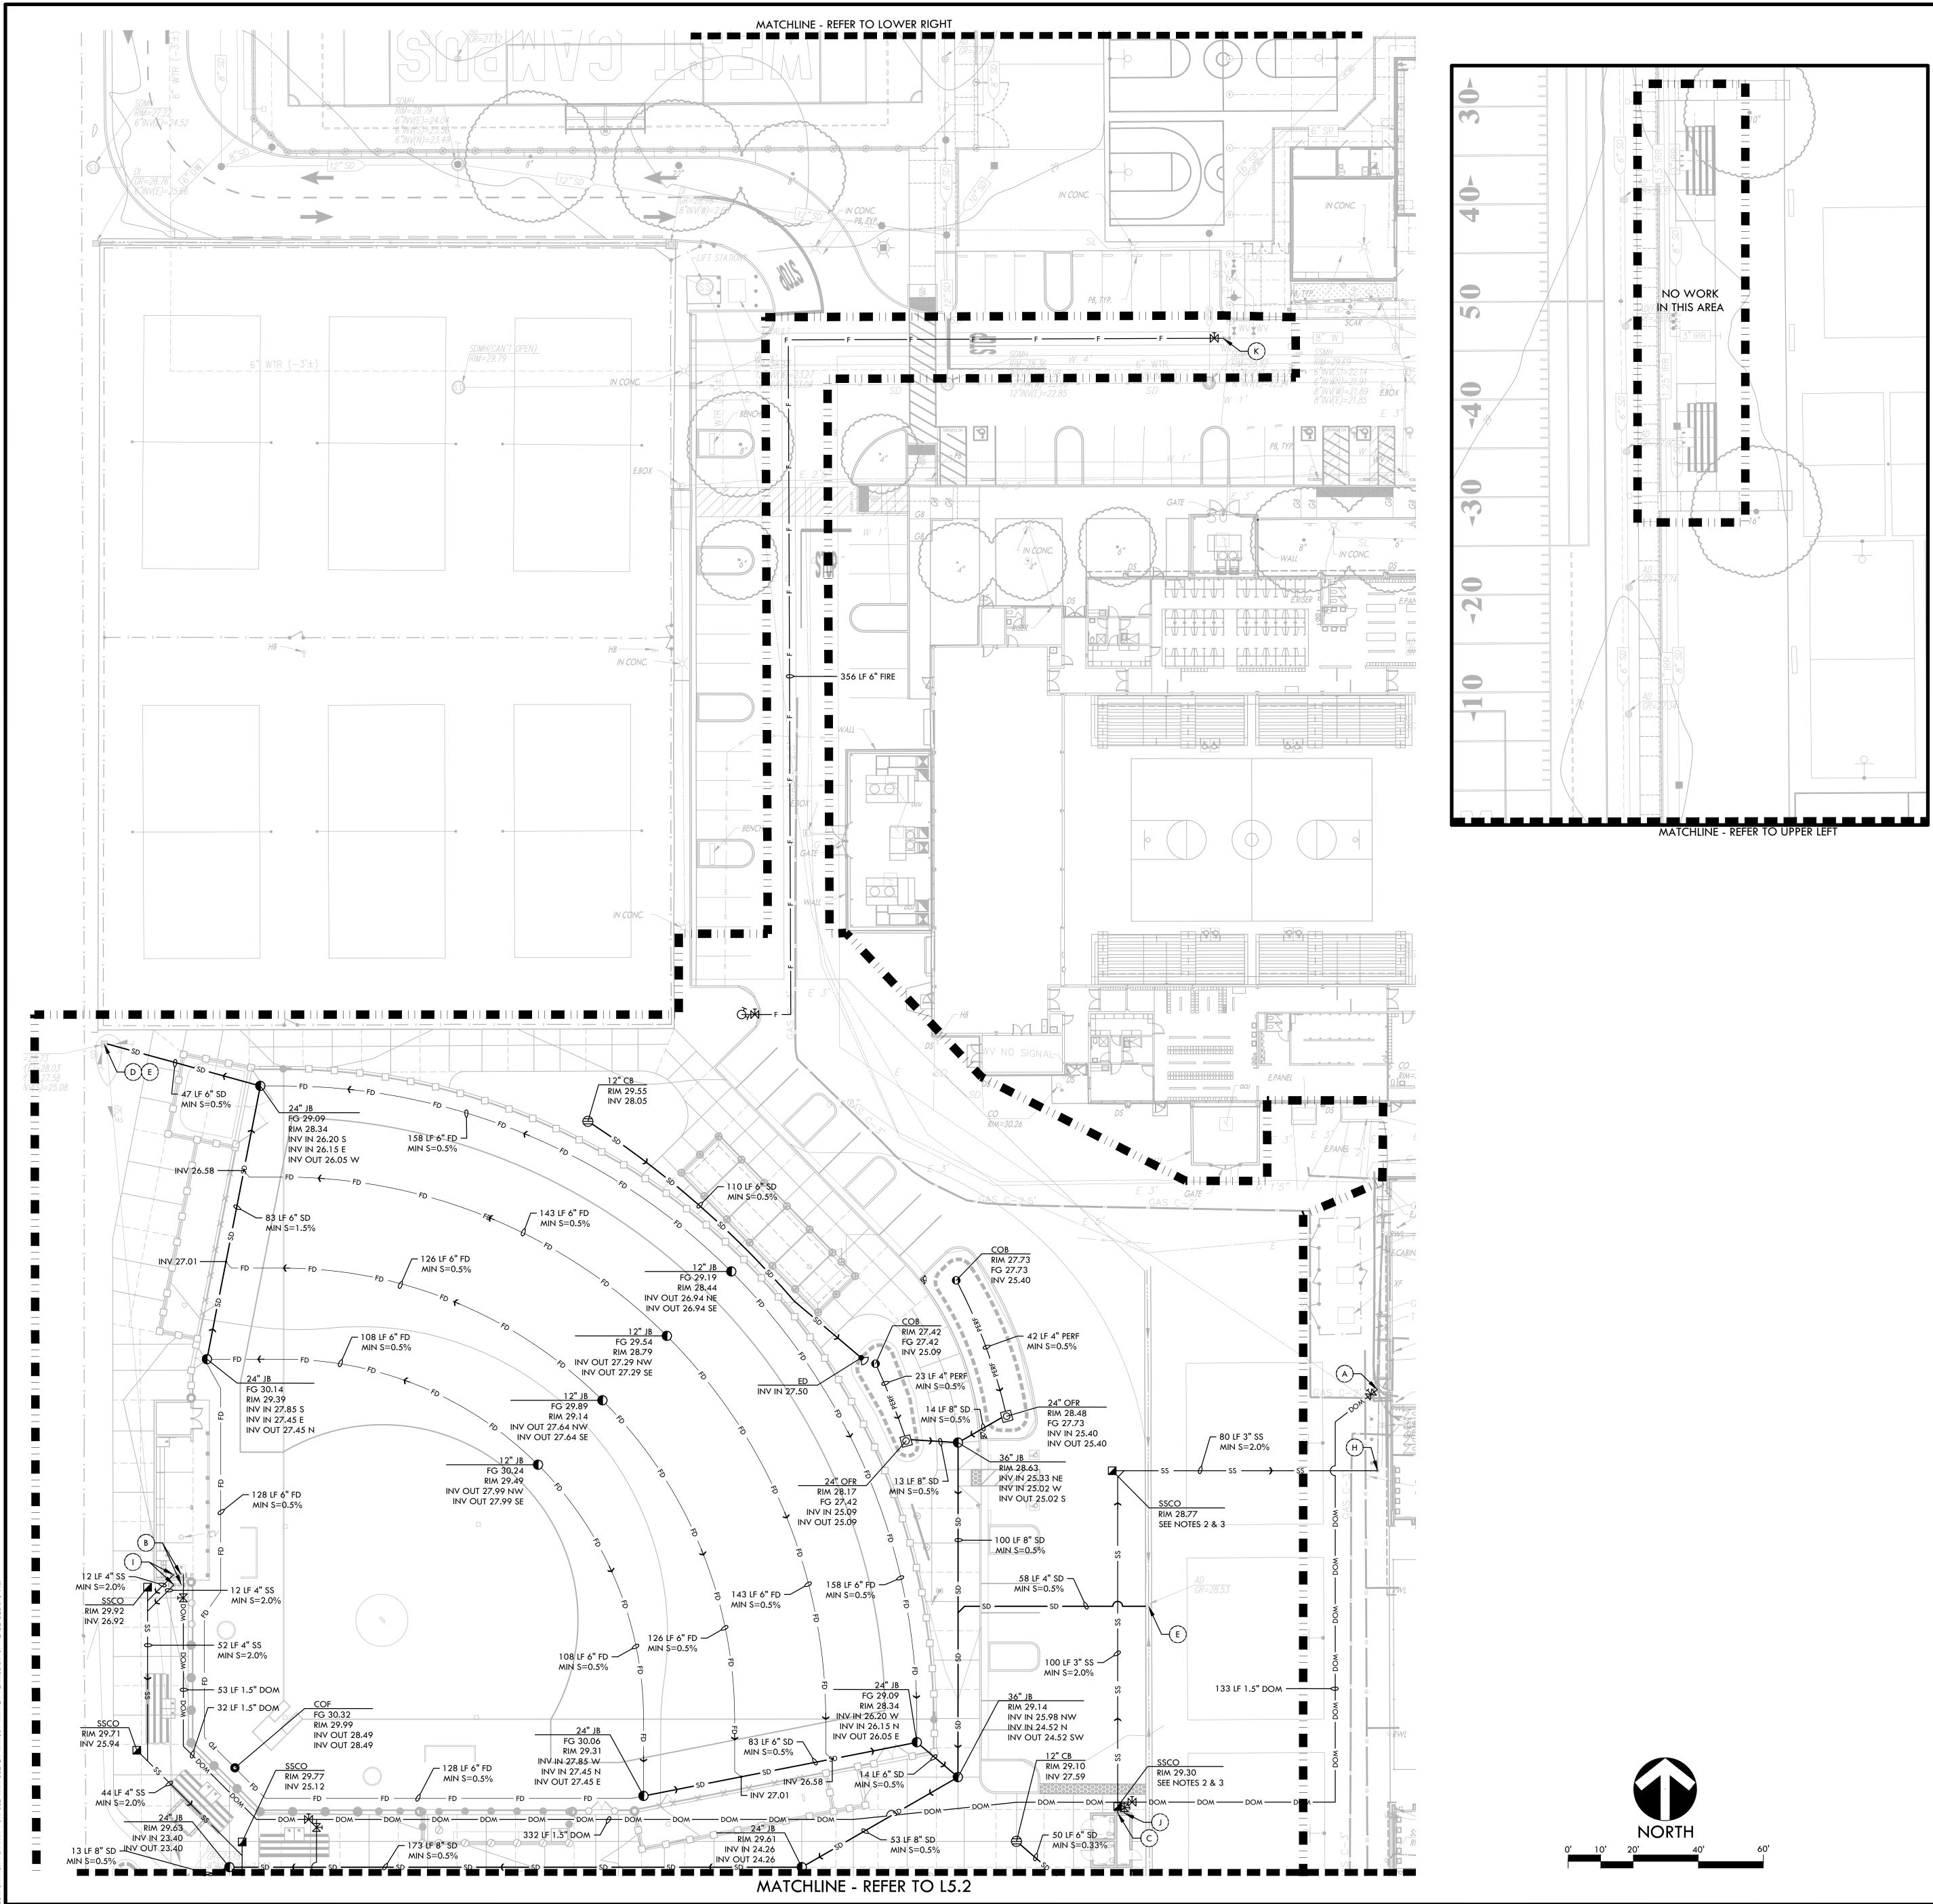
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| | SHEET TITLE | |
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| | WEST CAMPUS HIGH SCHOOL | |
| | BASEBALL & SOFTBA | ALL |
| | | |
| | project address 5022 58TH STREE | т |
| | SACRAMENTO, CA 95 | 5820 |
| | SUBMITTAL 50% SUBMITTAL | DATE 10/20/23 |
| | 100% DSA SUBMITTAL | 12/15/23 |
| | BACKCHECK SUBMITTAL | 03/18/24 |
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| | DATE ISSUED SCALE 03/18/2024 1"=20 PROJ. NO. | '-0" |
| | 2309900 Sheet NO. | |
| | L4.3 GRADING PLAN - ⁻ | TRACK |




DRAWING NAME: Y:\projects-fo\2023\2309900 - west campus hs\CAD_DRN-C3D.dwg PLOT DATE: 04-25-24 PLOTTED BY: station40-t


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| ROOTS S | HALL BE KEPT SHADED AND MOIST WITH DAMPENED BURLAP OR CANVAS. | |
|------------|--|----------|
| | DRAINAGE & UTILITY LEGEND | |
| SYM | DESCRIPTION DETAIL NUMBER - SHEET NUMBER - | |
| | LIMIT OF WORK | |
| | REPLACE EXISTING GRATE WITH SOLID LID | |
| ⊜ | CATCH BASIN, SIZE PER PLAN (CB) | (|
| Ð | JUNCTION BOX, SIZE PER PLAN (JB) | (|
| 0 | CLEANOUT IN BIORETENTION AREA (COB) | (|
| | SANITARY SEWER CLEANOUT (SSCO) | (|
| 0 | CLEANOUT IN FINES (COF) | (|
| Ф | DRY WELL FOR DRINKING FOUNTAIN (DW) | (|
| Ŕ | DOMESTIC WATER GATE VALVE | (|
| ゼ | FIRE HYDRANT | (|
| 0 | OVERFLOW RISER (OFR) WITH GRATE/STANDPIPE AT BIORETENTION AREA, SIZE PER PLAN | (|
| Þ | ENERGY DISSIPATOR (ED) | |
| SD-Y | SOLID WALL STORM DRAIN | |
| FD-Y | FRENCH DRAIN | |
| WD Y | WALL DRAIN | |
| PERF | INFILTRATION TRENCH AT BIORETENTION AREA | |
| 55-1 | SANITARY SEWER LINE | |
| DOM | DOMESTIC WATER LINE | |
| GAS | GAS LINE | |
| F | FIRE WATER LINE | |
| | BIORETENTION AREA (BOTTOM OF BIORETENTION BASIN) | |
| A | DOMESTIC WATER POINT OF CONNECTION. CONTRACTOR TO VERIFY LOCA INITIATING IMPROVEMENTS. ANY DISCREPANCY TO BE PROVIDED TO DISTRIC | |
| В | DOMESTIC WATER CONNECTION TO DRINKING FOUNTAIN | |
| C | DOMESTIC WATER CONNECTION TO BUILDING, REFER TO ARCHITECTURAL PLANS. | |
| D | STORM DRAIN POINT OF CONNECTION. CONTRACTOR TO VERIFY LOCATION ELEVATION PRIOR TO INITIATING IMPROVEMENTS. ANY DISCREPANCY TO BE DISTRICT IN WRITING. | |
| E | PROTECT EXISTING DRAIN INLET IN PLACE | |
| F | EXISTING STRUCTURE TO BE BURIED IN PLACE, REPLACE EXISTING GRATE WITH SOLID CAST IRON LID WITH MINIMUM 6" COVER IN INFIELD FINES AND 9" COVER IN GRASS | |
| G | ADJUST RIM ELEVATION TO PROPOSED GRADE, SEE GRADING PLAN ON SHE FOR ADDITIONAL INFORMATION | ETS L4.1 |
| H | SANITARY SEWER POINT OF CONNECTION. CONTRACTOR TO VERIFY LOCAT INVERT ELEVATION PRIOR TO INITIATING IMPROVEMENTS. ANY DISCREPANCY PROVIDED TO DISTRICT IN WRITING. | |
| | SANITARY SEWER CONNECTION TO DRINKING FOUNTAIN | |
| | SANITARY SEWER CONNECTION TO BUILDING, REFER TO ARCHITECTURAL PLANS. | |
| K | FIRE WATER POINT OF CONNECTION. CONTRACTOR TO VERIFY LOCATION P INITIATING IMPROVEMENTS. ANY DISCREPANCY TO BE PROVIDED TO DISTRIC | |
| L | GAS POINT OF CONNECTION. CONTRACTOR TO VERIFY LOCATION PRIOR TO IMPROVEMENTS. ANY DISCREPANCY TO BE PROVIDED TO DISTRICT IN WRITIN | |
| (E) | EXISTING | |
| INV | INVERT | |
| LF | LINEAR FEET | |
| MIN | MINIMUM | |
| RIM | RIM ELEVATION | |
| S=0.5% | SLOPE | |
| N, S, E, W | NORTH, SOUTH, EAST, WEST | |
| | DRAINAGE AND | UTIL |

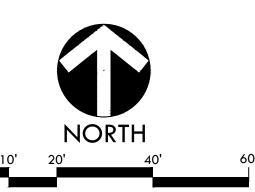

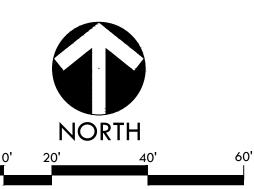


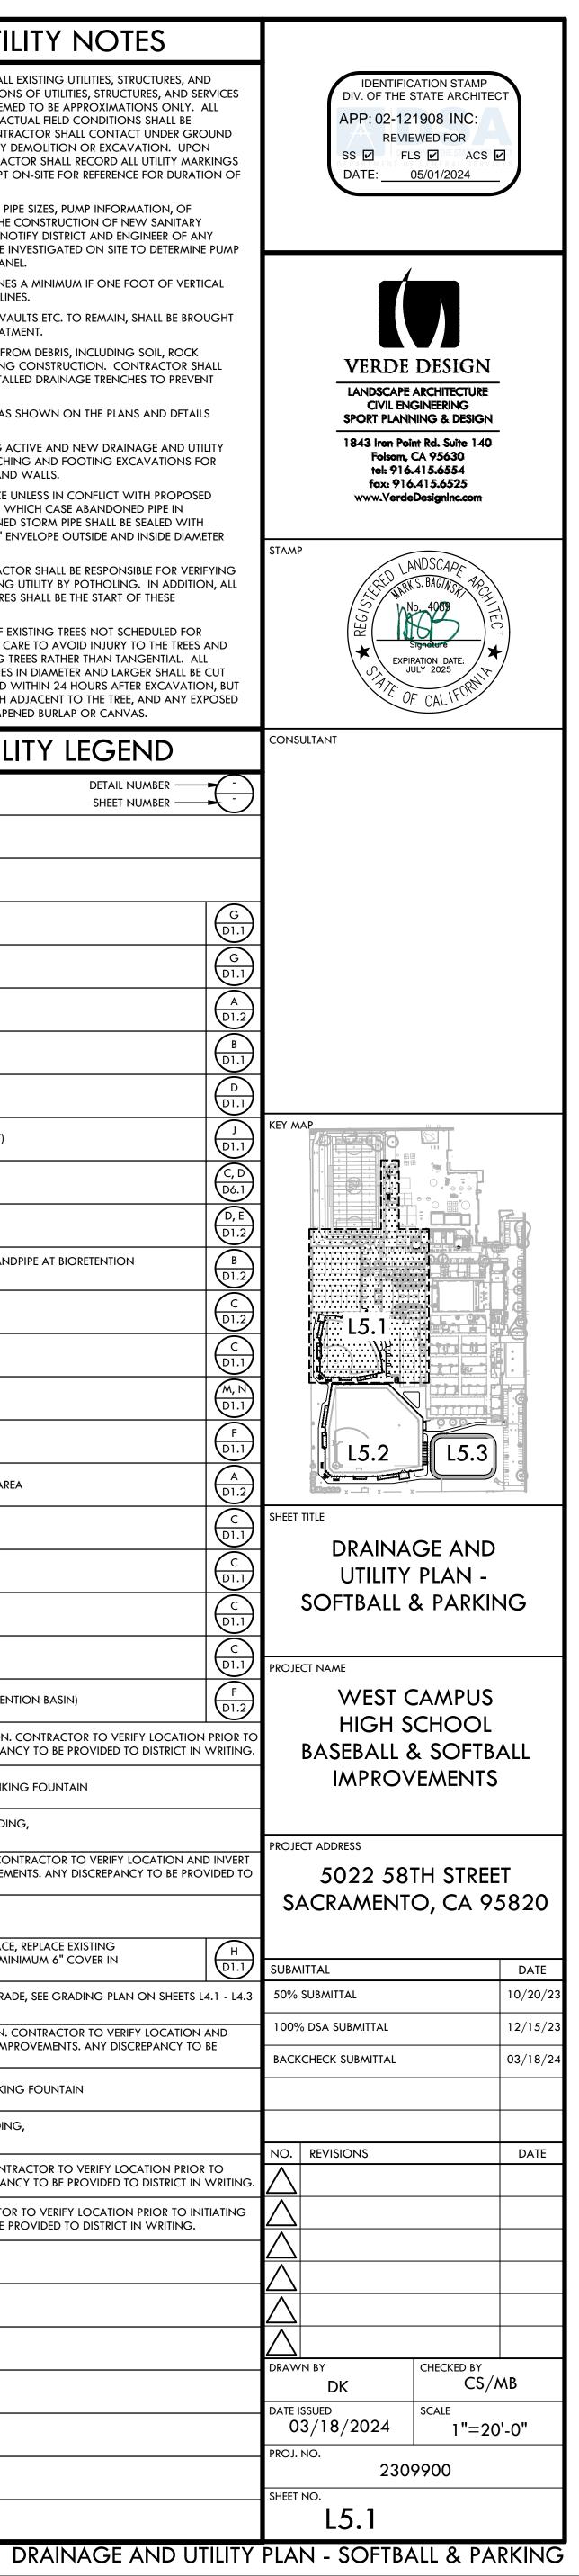



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| | DRAINAGE & UTILITY LEGEND | |
|--|--|----------|
| SYM | DESCRIPTION DETAIL NUMBER SHEET NUMBER | |
| | LIMIT OF WORK | |
| | REPLACE EXISTING GRATE WITH SOLID LID | |
| ⊜ | CATCH BASIN, SIZE PER PLAN (CB) | (|
| Ð | JUNCTION BOX, SIZE PER PLAN (JB) | (|
| 0 | CLEANOUT IN BIORETENTION AREA (COB) | (|
| | SANITARY SEWER CLEANOUT (SSCO) | (|
| 0 | CLEANOUT IN FINES (COF) | (|
| Ф | DRY WELL FOR DRINKING FOUNTAIN (DW) | (|
| 函 | DOMESTIC WATER GATE VALVE | (|
| ゼ | FIRE HYDRANT | (|
| 0 | OVERFLOW RISER (OFR) WITH GRATE/STANDPIPE AT BIORETENTION AREA, SIZE PER PLAN | |
| 4 | ENERGY DISSIPATOR (ED) | |
| SD-Y | SOLID WALL STORM DRAIN | |
| FD-Y | FRENCH DRAIN | |
| WDY | WALL DRAIN | |
| PERF | INFILTRATION TRENCH AT BIORETENTION AREA | |
| 55-1 | SANITARY SEWER LINE | |
| DOM | DOMESTIC WATER LINE | |
| GAS | GAS LINE | |
| IF I | FIRE WATER LINE | |
| IIIIIIIIIIIIIIIIIIIIIIIIIIIIIIIIIIIIII | BIORETENTION AREA (BOTTOM OF BIORETENTION BASIN) | |
| | DOMESTIC WATER POINT OF CONNECTION. CONTRACTOR TO VERIFY LOCA INITIATING IMPROVEMENTS. ANY DISCREPANCY TO BE PROVIDED TO DISTRI | |
| В | DOMESTIC WATER CONNECTION TO DRINKING FOUNTAIN | |
| C | DOMESTIC WATER CONNECTION TO BUILDING, REFER TO ARCHITECTURAL PLANS. | |
| D | STORM DRAIN POINT OF CONNECTION. CONTRACTOR TO VERIFY LOCATIO ELEVATION PRIOR TO INITIATING IMPROVEMENTS. ANY DISCREPANCY TO BE DISTRICT IN WRITING. | |
| E | PROTECT EXISTING DRAIN INLET IN PLACE | |
| F | EXISTING STRUCTURE TO BE BURIED IN PLACE, REPLACE EXISTING GRATE WITH SOLID CAST IRON LID WITH MINIMUM 6" COVER IN INFIELD FINES AND 9" COVER IN GRASS | |
| G | ADJUST RIM ELEVATION TO PROPOSED GRADE, SEE GRADING PLAN ON SHI FOR ADDITIONAL INFORMATION | ETS L4.1 |
| H | SANITARY SEWER POINT OF CONNECTION. CONTRACTOR TO VERIFY LOCA INVERT ELEVATION PRIOR TO INITIATING IMPROVEMENTS. ANY DISCREPANC | |
| | PROVIDED TO DISTRICT IN WRITING. SANITARY SEWER CONNECTION TO DRINKING FOUNTAIN | |
| | SANITARY SEWER CONNECTION TO BUILDING, REFER TO ARCHITECTURAL PLANS. | |
| K | FIRE WATER POINT OF CONNECTION. CONTRACTOR TO VERIFY LOCATION INITIATING IMPROVEMENTS. ANY DISCREPANCY TO BE PROVIDED TO DISTRI | |
| L | GAS POINT OF CONNECTION. CONTRACTOR TO VERIFY LOCATION PRIOR 1 IMPROVEMENTS. ANY DISCREPANCY TO BE PROVIDED TO DISTRICT IN WRITI | |
| (E) | EXISTING | |
| INV | INVERT | |
| LF | LINEAR FEET | |
| MIN | MINIMUM | |
| RIM | RIM ELEVATION | |
| S=0.5% | SLOPE | |
| N, S, E, W | NORTH, SOUTH, EAST, WEST | |
| | DRA | |

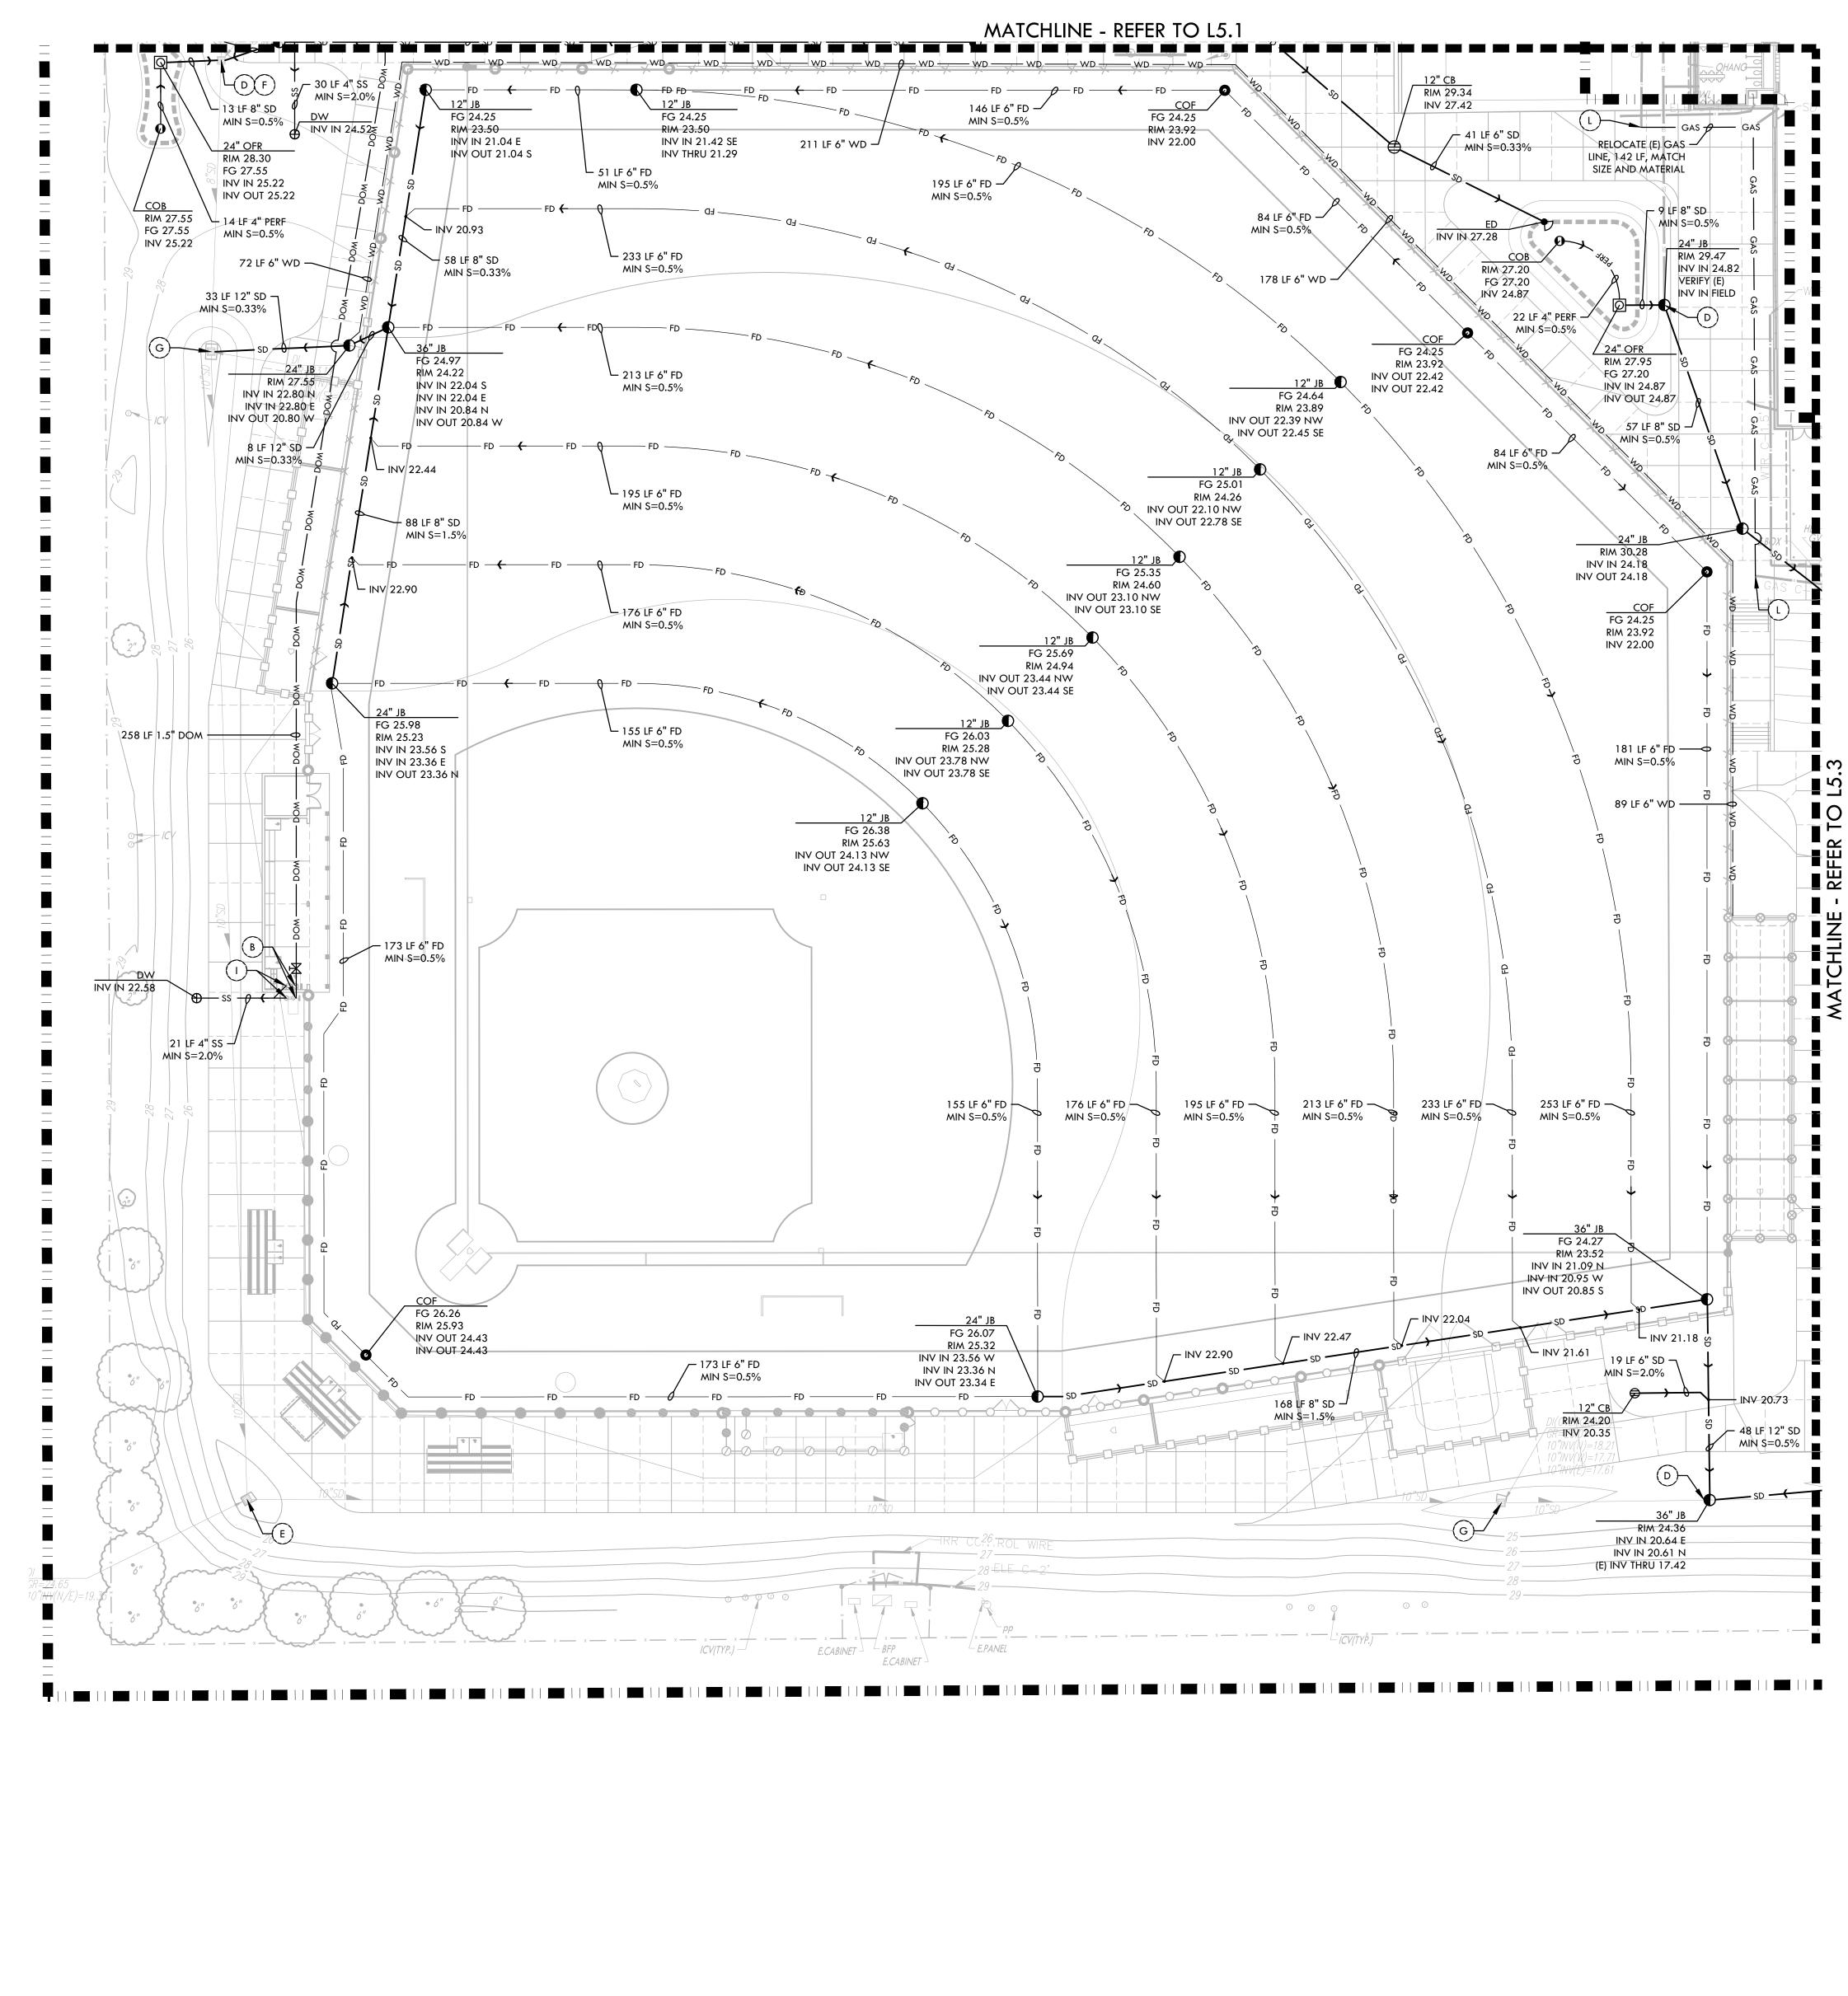




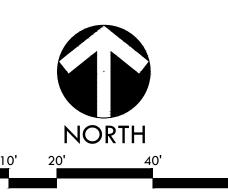


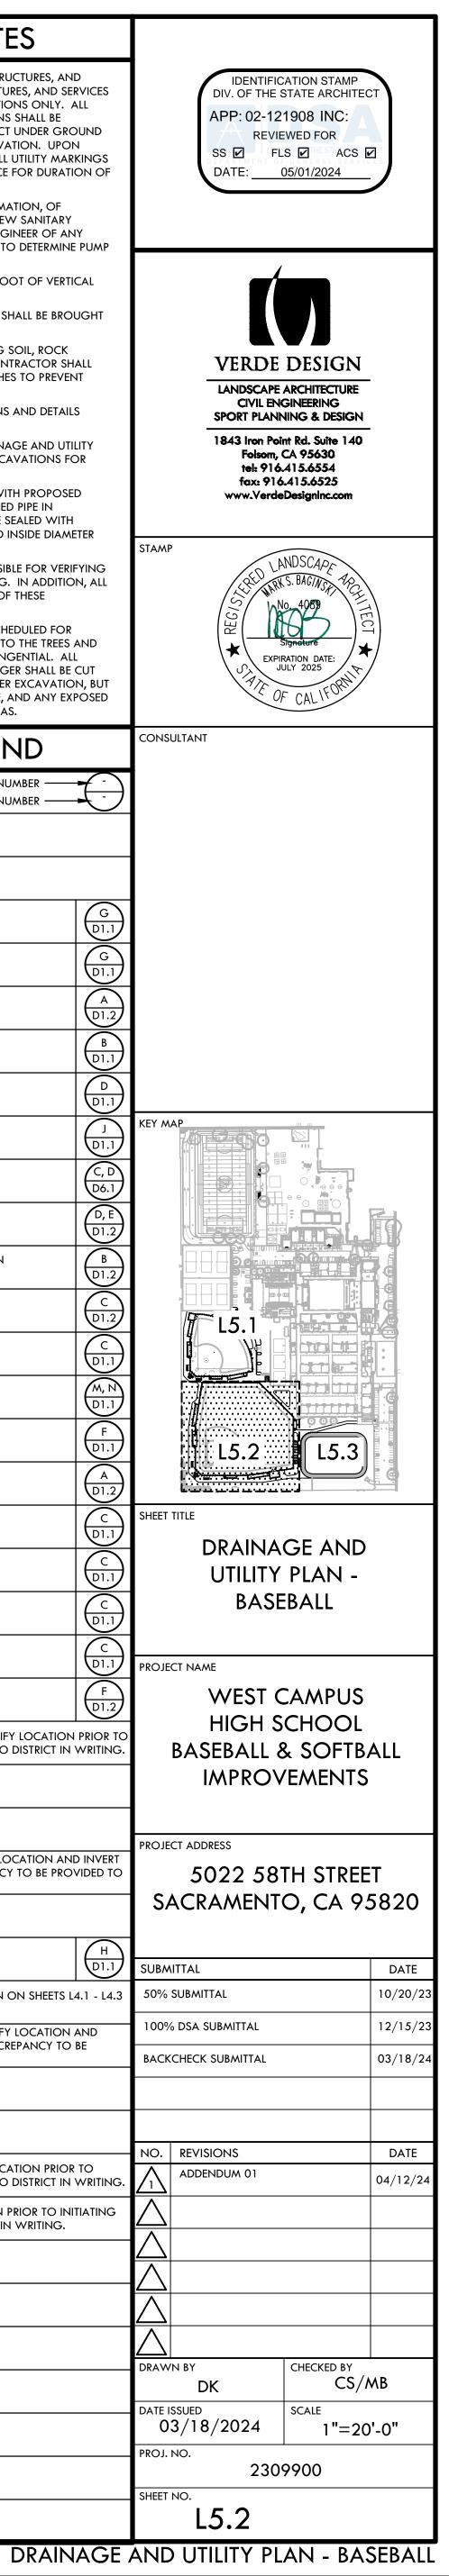
DRAINAGE & UTILITY NOTES

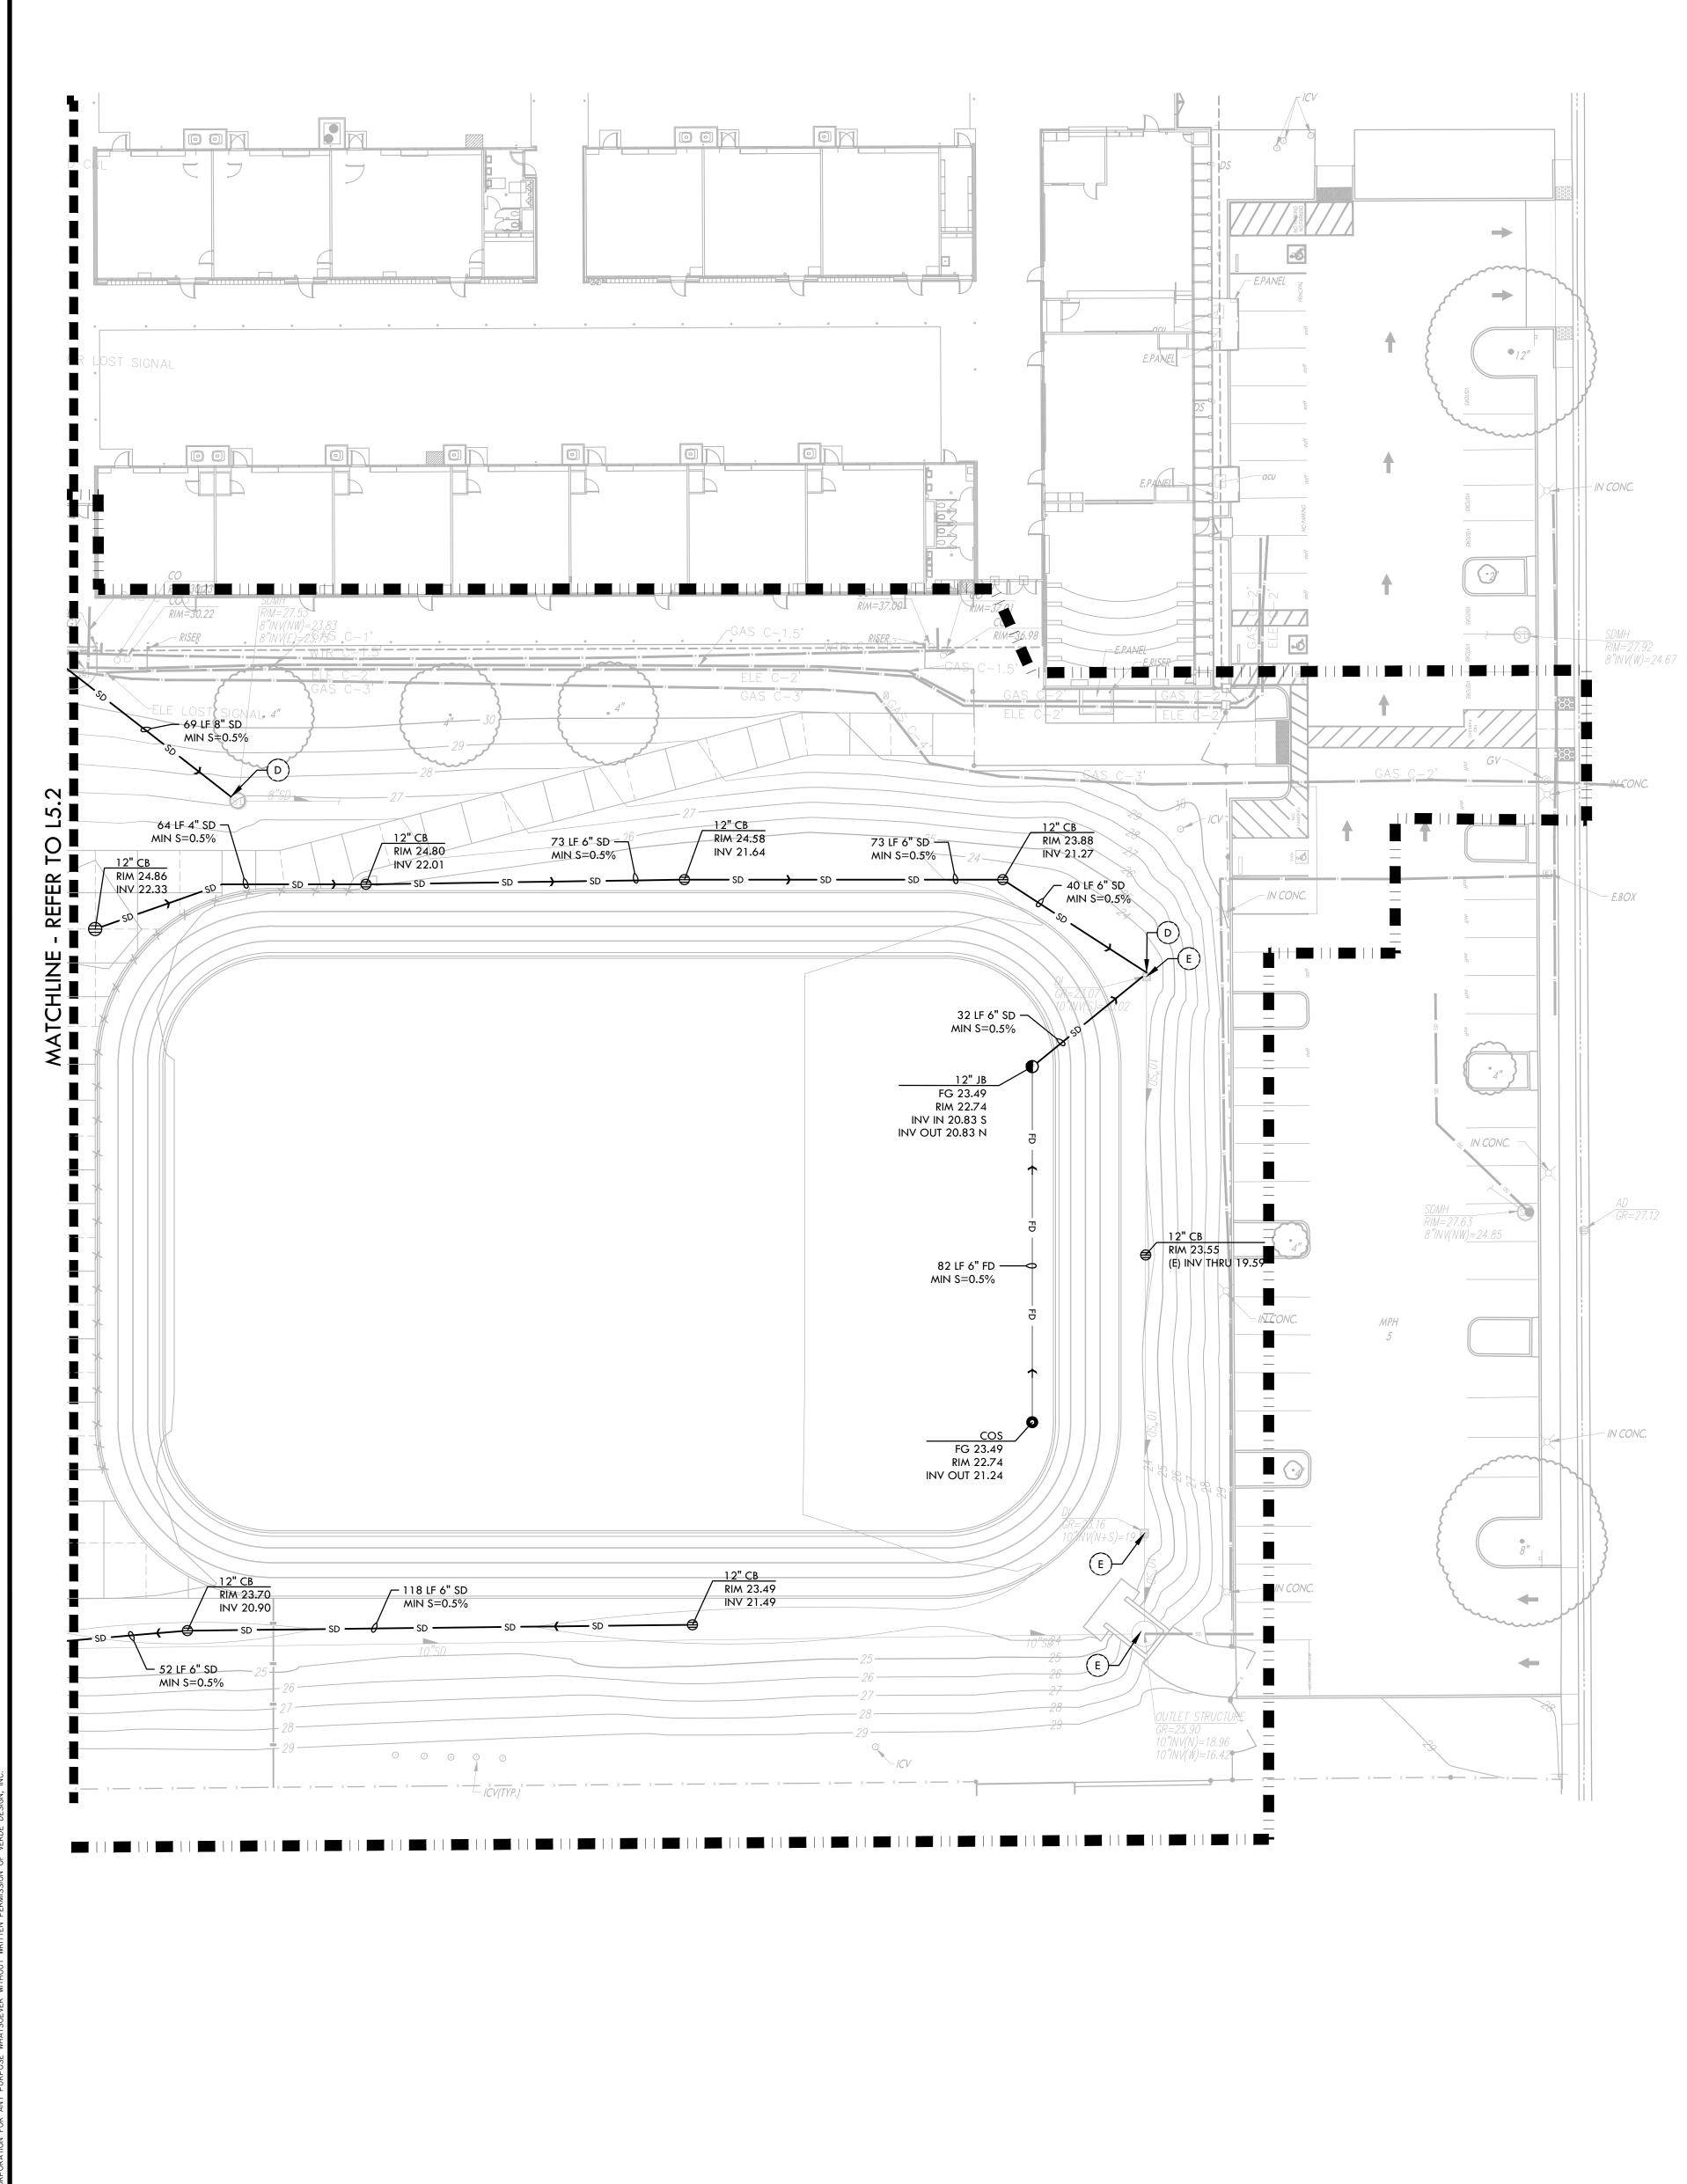- THE CONTRACTOR SHALL VERIFY THE LOCATIONS OF ALL EXISTING UTILITIES, STRUCTURES, AND SERVICES BEFORE COMMENCING WORK. THE LOCATIONS OF UTILITIES, STRUCTURES, AND SERVICES SHOWN IN THE CONTRACT DOCUMENTS SHALL BE DEEMED TO BE APPROXIMATIONS ONLY. ALL DISCREPANCIES BETWEEN WHAT IS SHOWN AND THE ACTUAL FIELD CONDITIONS SHALL BE REPORTED TO THE DISTRICT REPRESENTATIVE. THE CONTRACTOR SHALL CONTACT UNDER GROUND SERVICE ALERT (USA) AT (800) 227-2600 PRIOR TO ANY DEMOLITION OR EXCAVATION. UPON COMPLETION OF USA MARKING OPERATIONS, CONTRACTOR SHALL RECORD ALL UTILITY MARKINGS ON A SEPARATE SET OF DRAWINGS AND SHALL BE KEPT ON-SITE FOR REFERENCE FOR DURATION OF CONTRACT.
- THE CONTRACTOR SHALL FIELD VERIFY INVERT DEPTHS, PIPE SIZES, PUMP INFORMATION, OF EXISTING SANITARY SEWER LINES ON SITE PRIOR TO THE CONSTRUCTION OF NEW SANITARY SEWER LINES. THE CONTRACTOR SHALL IMMEDIATELY NOTIFY DISTRICT AND ENGINEER OF ANY DISCREPANCIES. THE EXISTING PRESSURE LINE SHALL BE INVESTIGATED ON SITE TO DETERMINE PUMP LOCATION, TYPE, CAPACITY, CONTROL, AND ALARM PANEL.
- THE CONTRACTOR SHALL INSTALL SANITARY SEWER LINES A MINIMUM IF ONE FOOT OF VERTICAL CLEARANCE BELOW WATER LINES AND STORM DRAIN LINES.
- ALL EXISTING DRAINAGE STRUCTURES, BOXES, UTILITY VAULTS ETC. TO REMAIN, SHALL BE BROUGHT TO FINAL FINISH GRADE PRIOR TO FINAL SURFACE TREATMENT. THE CONTRACTOR IS TO PROTECT DRAINAGE SYSTEM FROM DEBRIS, INCLUDING SOIL, ROCK
- MATERIAL, AND TRASH FROM ENTERING THE PIPE DURING CONSTRUCTION. CONTRACTOR SHALL AVOID PLACING CONSTRUCTION VEHICLES OVER INSTALLED DRAINAGE TRENCHES TO PREVENT CRUSHING OF PIPE. COORDINATE ALL SLEEVING AND UTILITY LOCATIONS AS SHOWN ON THE PLANS AND DETAILS
- CONTAINED WITHIN THESE CONTRACT DOCUMENTS. THE CONTRACTOR IS TO ENSURE THAT ALL REMAINING ACTIVE AND NEW DRAINAGE AND UTILITY LINES ARE PROTECTED AND UNDAMAGED FROM TRENCHING AND FOOTING EXCAVATIONS FOR
- NEW FOOTINGS, PARTICULARLY FOR NEW FENCING AND WALLS. ALL ABANDONED STORM LINES SHALL REMAIN IN PLACE UNLESS IN CONFLICT WITH PROPOSED DRAINAGE, UTILITY, OR SUBGRADING OPERATIONS, IN WHICH CASE ABANDONED PIPE IN CONFLICT SHALL BE REMOVED. REMAINING ABANDONED STORM PIPE SHALL BE SEALED WITH APPROPRIATELY SIZED CONCRETE CAP (3 SACK MIX) 6" ENVELOPE OUTSIDE AND INSIDE DIAMETER
- OF PIPE. PRIOR TO ALL DRAINAGE AND UTILITY WORK, CONTRACTOR SHALL BE RESPONSIBLE FOR VERIFYING ALL POTENTIAL DRAINAGE CONNECTIONS AND EXISTING UTILITY BY POTHOLING. IN ADDITION, ALL DOWNSTREAM CONNECTIONS TO EXISTING STRUCTURES SHALL BE THE START OF THESE OPERATIONS, AND GRADES SHALL BE VERIFIED.
- WHEN WORK HAS TO OCCUR UNDER THE DRIPLINE OF EXISTING TREES NOT SCHEDULED FOR REMOVAL, THE CONTRACTOR SHALL USE ALL POSSIBLE CARE TO AVOID INJURY TO THE TREES AND TREE ROOTS. GRADE IN LINES RADIAL TO THE EXISTING TREES RATHER THAN TANGENTIAL. ALL PARTIAL CUTS OR TEARS THROUGH ROOTS TWO INCHES IN DIAMETER AND LARGER SHALL BE CUT CLEAN. TRENCHES ADJACENT TO TREES SHALL BE FILLED WITHIN 24 HOURS AFTER EXCAVATION, BUT WHERE THIS IS NOT POSSIBLE, THE SIDE OF THE TRENCH ADJACENT TO THE TREE, AND ANY EXPOSED ROOTS SHALL BE KEPT SHADED AND MOIST WITH DAMPENED BURLAP OR CANVAS.

| | DRAINAGE & UTILITY LEG | END | |
|------------|--|----------------------------|--------|
| SYM | I DESCRIPTION | IL NUMBER — ET NUMBER — | |
| | LIMIT OF WORK | | |
| | REPLACE EXISTING GRATE WITH SOLID LID | | |
| | CATCH BASIN, SIZE PER PLAN (CB) | | (|
| Ð | JUNCTION BOX, SIZE PER PLAN (JB) | | (|
| 0 | CLEANOUT IN BIORETENTION AREA (COB) | | (|
| | SANITARY SEWER CLEANOUT (SSCO) | | (|
| 0 | CLEANOUT IN FINES (COF) | | |
| Ð | DRY WELL FOR DRINKING FOUNTAIN (DW) | | |
| 凼 | DOMESTIC WATER GATE VALVE | | |
| な | FIRE HYDRANT | | |
| O | OVERFLOW RISER (OFR) WITH GRATE/STANDPIPE AT BIORETENTI AREA, SIZE PER PLAN | ON | (|
| 4 | ENERGY DISSIPATOR (ED) | | (|
| SD | SOLID WALL STORM DRAIN | | + |
| FD-Y | FRENCH DRAIN | | + |
| WD Y | WALL DRAIN | | |
| PERF | INFILTRATION TRENCH AT BIORETENTION AREA | | |
| 55 1 | SANITARY SEWER LINE | | |
| DOM | DOMESTIC WATER LINE | | |
| GAS | GAS LINE | | |
| , F | FIRE WATER LINE | | (|
| | BIORETENTION AREA (BOTTOM OF BIORETENTION BASIN) | | (|
| A | DOMESTIC WATER POINT OF CONNECTION. CONTRACTOR TO V INITIATING IMPROVEMENTS. ANY DISCREPANCY TO BE PROVIDED | | |
| B | DOMESTIC WATER CONNECTION TO DRINKING FOUNTAIN | | |
| C | DOMESTIC WATER CONNECTION TO BUILDING, REFER TO ARCHITECTURAL PLANS. | | |
| D | STORM DRAIN POINT OF CONNECTION. CONTRACTOR TO VERIF ELEVATION PRIOR TO INITIATING IMPROVEMENTS. ANY DISCREP DISTRICT IN WRITING. | | |
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| G | ADJUST RIM ELEVATION TO PROPOSED GRADE, SEE GRADING PL FOR ADDITIONAL INFORMATION | AN ON SHEET | S L4.1 |
| H | SANITARY SEWER POINT OF CONNECTION. CONTRACTOR TO VI INVERT ELEVATION PRIOR TO INITIATING IMPROVEMENTS. ANY D PROVIDED TO DISTRICT IN WRITING. | | |
| | SANITARY SEWER CONNECTION TO DRINKING FOUNTAIN | | |
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| L | GAS POINT OF CONNECTION. CONTRACTOR TO VERIFY LOCATION IMPROVEMENTS. ANY DISCREPANCY TO BE PROVIDED TO DISTRIC | | |
| (E) | EXISTING | | |
| INV | INVERT | | |
| LF | LINEAR FEET | | |
| MIN | MINIMUM | | |
| RIM | RIM ELEVATION | | |
| S=0.5% | SLOPE | | |
| N, S, E, W | NORTH, SOUTH, EAST, WEST | | |
| | | D | RAI |

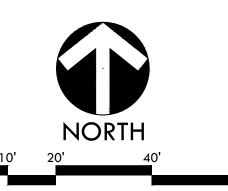

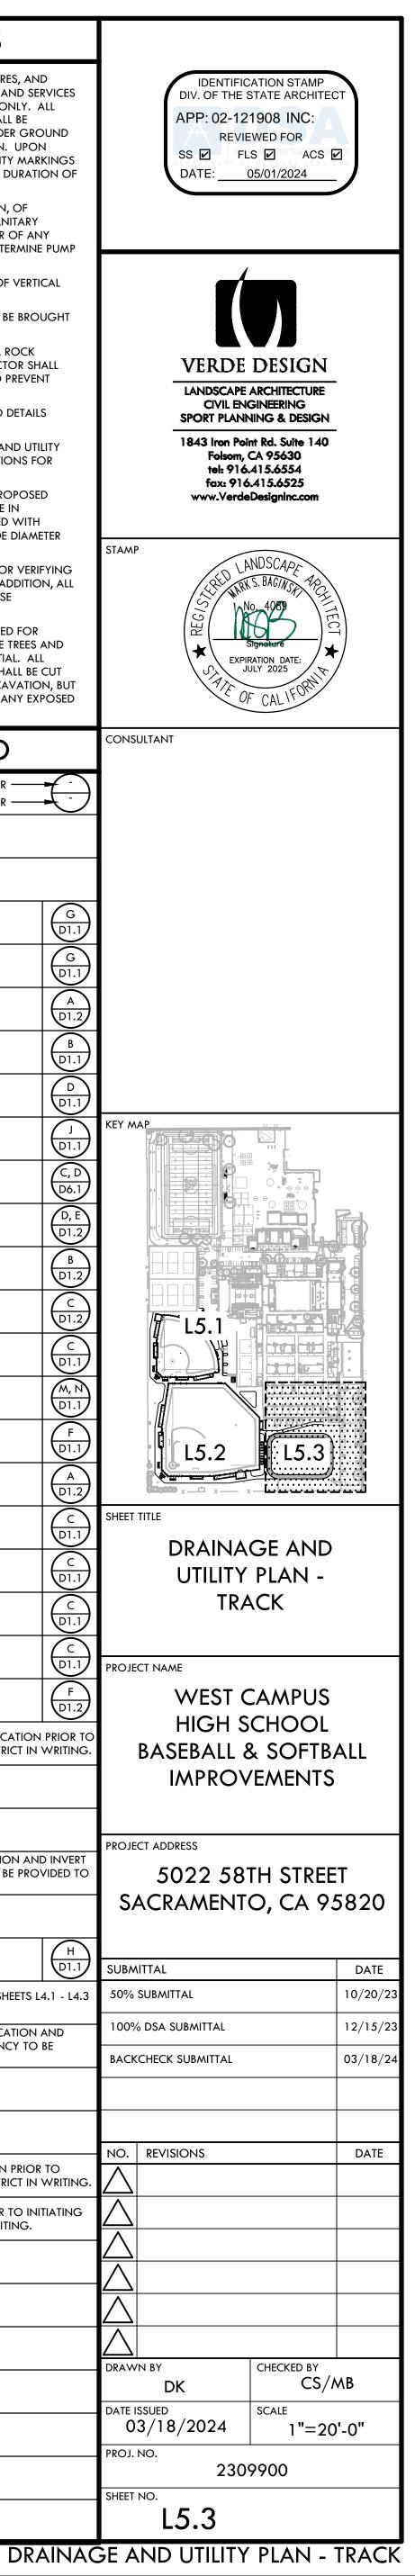

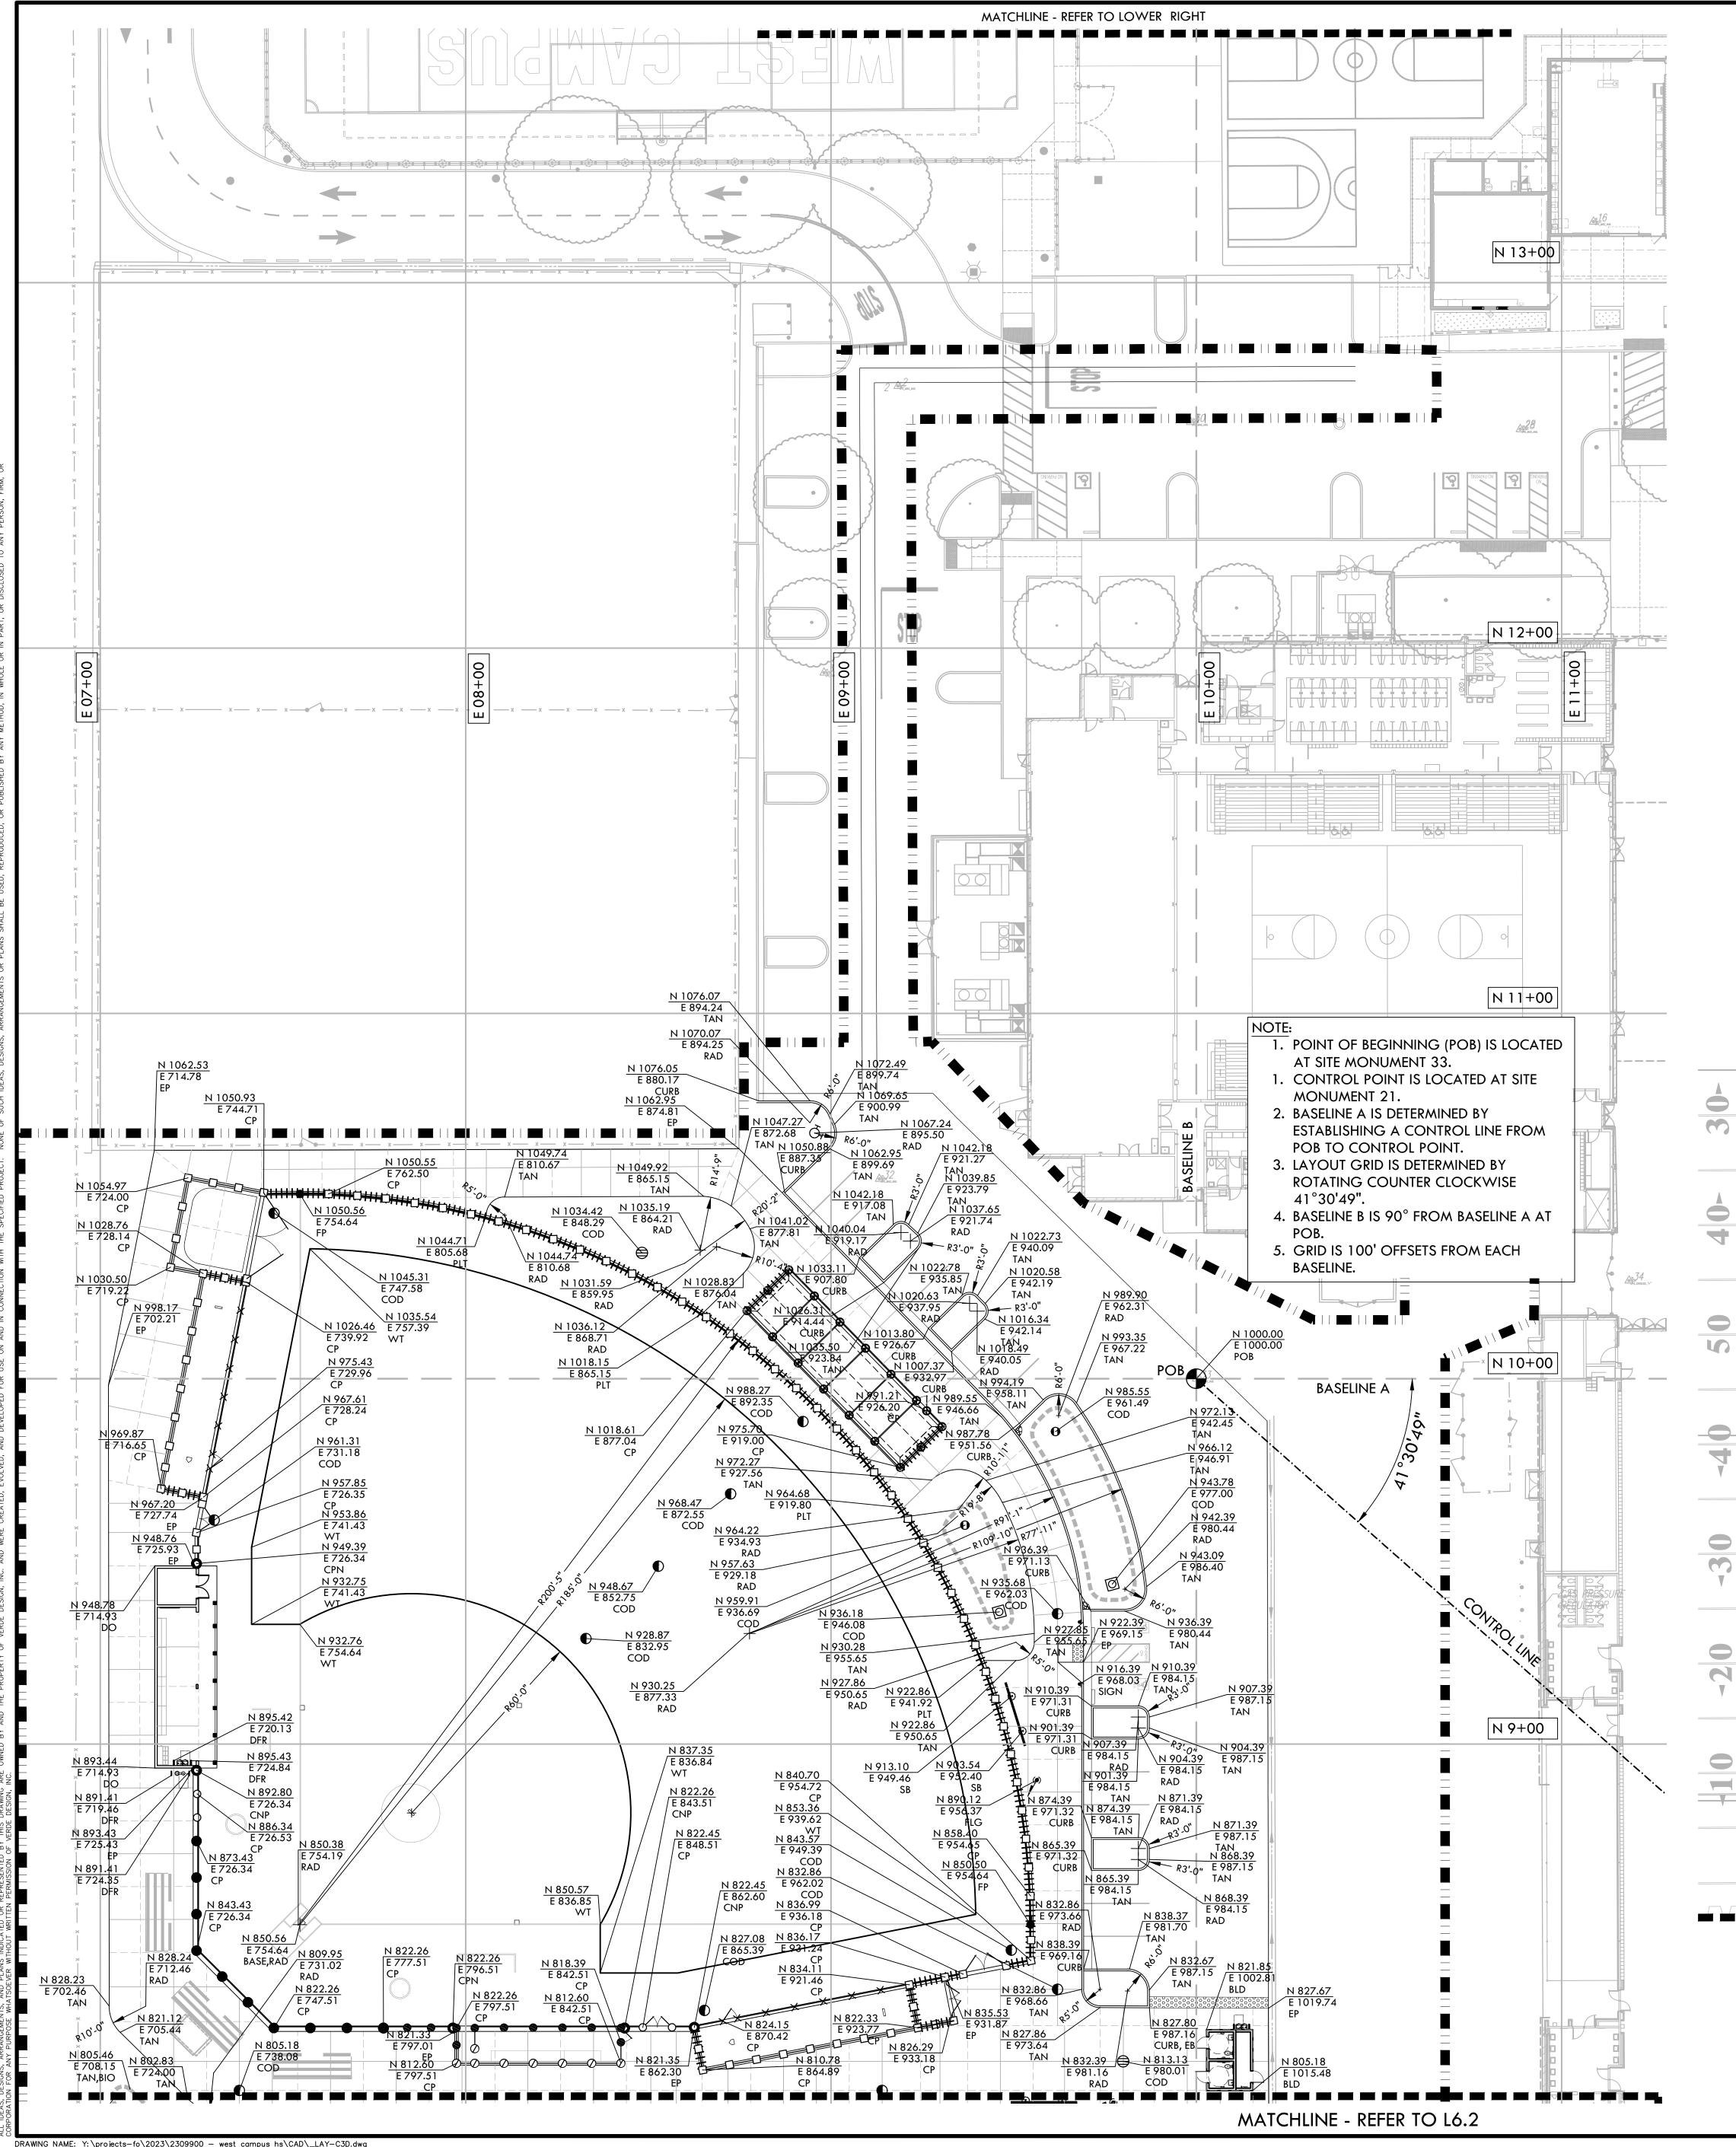


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LAYOUT NOTES

- THE CONTRACTOR SHALL COORDINATE ALL CONSTRUCTION ELEMENTS INCLUDING UTILITY LOCATIONS AND REQUIRED SLEEVING PRIOR TO INSTALLATION. VERIFY CRITICAL DIMENSIONS, REFERENCE POINT LOCATIONS AND CONSTRUCTION CONDITIONS PRIOR TO INITIATING CONSTRUCTION. TEMPORARY BENCHMARKS OR REFERENCE POINTS SHALL BE SET BY THE CONTRACTOR AS NECESSARY. NOTIFY THE OWNER'S REPRESENTATIVE IMMEDIATELY SHOULD DISCREPANCY ARISE AND REDIRECT WORK TO AVOID DELAYS. ALL DIMENSIONS SHALL BE VERIFIED IN FIELD AND CHALKED, STRING LINED OR FLAGGED BY THE CONTRACTOR PRIOR TO CONSTRUCTION. ANY MINOR ADJUSTMENTS MADE TO ACHIEVE OVERALL DESIGN LAYOUT SHALL BE ACCEPTED BY THE OWNER PRIOR TO CONSTRUCTION. LAYOUT IS BASED ON THE POINT(S) OF BEGINNING (P.O.B.) AND BASELINE(S) OR GRID
- SYSTEM AS SHOWN. DIMENSIONS SHOWN ARE ROUNDED TO THE NEAREST INCH. 4. ALL LAYOUT AND GRADES SHALL BE COMPLETED BY A LICENSED SURVEYOR.
- SURVEY PROVIDED BY: WARREN CONSULTING ENGINEER (FIELD COMPLETION DATE: 07/27/17)
- 5.1. ASSESSOR'S PARCEL NO.: 023-0010-002 5.2. ELEVATIONS SHOWN HEREON ARE BASED UPON SACRAMENTO CITY BENCHMARK 317-J3, ELEVATION 29.969 FEET (NAVD 88): HILTI NAIL AT SE CORNER OF 21ST AVENUE AND 58TH STREET

| HILTI NAIL AT SE CORNER OF 21ST AVENUE AND 58TH STREET | | | |
|--|---|--|--|
| | LAYOUT LEGEND | | |
| SYM | DESCRIPTION | | |
| | LIMIT OF WORK | | |
| РОВ | POINT OF BEGINNING - LOCATED ON SHEET L7.1 | | |
| ۲ | ANCHOR POINT FOR CONTROL LINE - LOCATED ON SHEET L7.3 | | |
| P10, | RADIUS POINT / CENTER MARK | | |
| 900, | PROPOSED ANGLE BETWEEN ELEMENTS | | |
| ALIGN | ALIGN EDGES OF ELEMENTS | | |
| <u>∤ ×"</u> ∤ | DISTANCE BETWEEN ELEMENTS | | |
| | CENTER LINES | | |
| | BASELINE | | |
| | CONTROL LINE | | |
| N 6+21.95 E 4+97.08 | NORTHING/EASTING LAYOUT COORDINATE CALLOUT | | |
| (BLD) | BUILDING CORNER | | |
| (BASE) | POINT OF HOME BASE | | |
| (COD) | CENTER OF DRAINAGE STRUCTURE | | |
| (CP) | CENTER OF POST | | |
| (CNP) | CENTER OF NETTING POST | | |
| (CONTROL) | CONTROL POINT | | |
| (CURB) | CURB | | |
| (DFR) | CENTER OF DRINKING FOUNTAIN RAIL | | |
| (EB) | EDGEBAND | | |
| (EP) | EDGE OF PAVEMENT | | |
| (FLG) | CENTER OF FLAG POST | | |
| (FP) | CENTER OF FOUL POLE | | |
| (HEADER) | HEADERBOARD | | |
| (PLT) | PLANTER EDGE | | |
| (POB) | POINT OF BEGINNING FOR GRID LAYOUT | | |
| (RAD) | RADIUS POINT | | |
| (SB) | SCOREBOARD | | |
| (TAN) | TANGENT POINT | | |
| (TS) | TOP OF STAIR | | |
| (WALL) | WALL EDGE | | |
| (WT) | WARNING TRACK EDGE | | |
| | | | |



NORTH

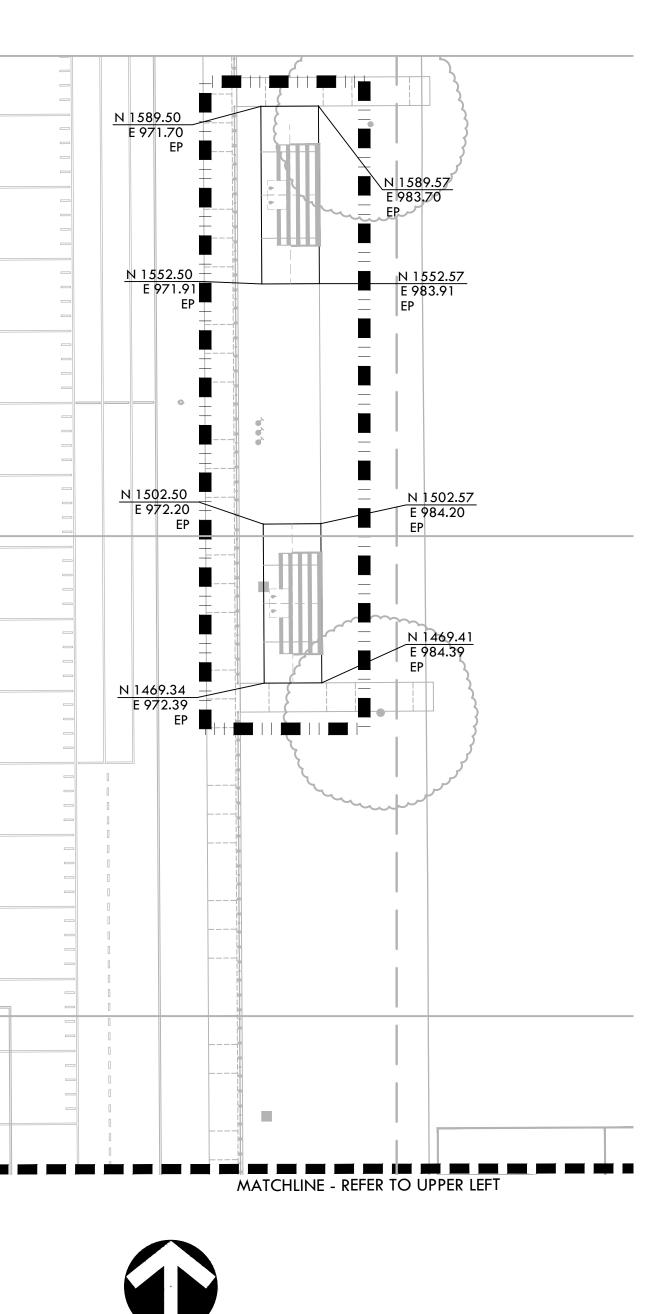